					DEPARTMENT	T OF NA	OF UTAH TURAL RES GAS AND M				AMENI	FC DED REPOR	RM 3		
		AF	PLICATION I	FOR P	ERMIT TO DRILL					1. WELL NAME and NU	JMBER GMBU D	-31-8-18			
2. TYPE O	F WORK	DRILL NEW WELL	REENTE	R P&A	WELL DEEPEN	N WELL [)			3. FIELD OR WILDCAT	T EIGHT MI	LE FLAT			
4. TYPE O	F WELL				I Methane Well: NO					5. UNIT or COMMUNIT	FIZATION GMBU (ENT NAM	IE .	
6. NAME C	F OPERATOR				FION COMPANY					7. OPERATOR PHONE	`				
8. ADDRES	SS OF OPERAT	OR	Rt 3 Box 363	0 . Mvt	ton, UT, 84052					9. OPERATOR E-MAIL		ewfield.co	m		
	AL LEASE NUM ., INDIAN, OR S	TATE)		1	11. MINERAL OWNERS	(E)) STATE () FEE()	12. SURFACE OWNERS	-	STATE	F	EE (
13. NAME	OF SURFACE		= 'fee')							14. SURFACE OWNER	PHONE	(if box 12	= 'fee')		
15. ADDRI	ESS OF SURFA	CE OWNER (if box	12 = 'fee')							16. SURFACE OWNER	R E-MAIL	(if box 12	= 'fee')		
	ME OF SURFACE OWNER (if box 12 = 'fee') 14. SURFACE OWNER PHONE (if box 12 = 'fee')														
(if box 12	= 'INDIAN')				(T)		ling Applicat	ion) NO 🤅	D)	VERTICAL DIF	RECTIONA	L 📵 H	IORIZONT	AL 🔵	
20. LOCA	TION OF WELL			FOC	OTAGES	QT	r-qtr	SECT	ION	TOWNSHIP	R/	NGE	МЕ	RIDIAN	
				62 FSL	535 FWL	S	SWSW	30)	8.0 S	18	3.0 E		S	
Top of U	ppermost Prod	Rt 3 Box 3 UMBER R STATE)		14 FSL	SL 1069 FWL		SWSW	30	8.0 S		18.0 E			s	
At Total Depth 158 FN					1482 FWL	N	NENW	31		8.0 S	18	3.0 E		S	
21. COUN	TY	UINTAH		2	22. DISTANCE TO NEA			eet)		23. NUMBER OF ACRE			IT		
						or Comp	pleted)	POOL				TVD: 620	0		
27. ELEVATION - GROUND LEVEL 4994					WATER RIGHTS APPROVAL NUMBER IF APPLICABLE					LE					
					Hole, Casing	g, and C	ement Info	ormation							
String Surf	Hole Size	_		Weig 24	_		Max Mu		***************************************			Sacks 138	Yield 1.17	Weight 15.8	
Prod	7.875		0 - 6346	15			8.3		Prer	Class G nium Lite High Strer	nath	300	3.26	11.0	
										50/50 Poz	J .	363	1.24	14.3	
					A	ATTACH	IMENTS	,							
	VER	IFY THE FOLLO	WING ARE A	TTACH	HED IN ACCORDAN	NCE WIT	TH THE UT	AH OIL AN	ID GAS	CONSERVATION G	ENERA	L RULES			
✓ wi	ELL PLAT OR M	AP PREPARED BY	LICENSED SUR	VEYOR	OR ENGINEER		⊯ cow	IPLETE DRII	LLING P	LAN					
AF	FIDAVIT OF STA	TUS OF SURFACE	OWNER AGREE	EMENT	(IF FEE SURFACE)		FOR	M 5. IF OPER	RATOR I	S OTHER THAN THE LE	EASE OW	NER			
I DIF	RECTIONAL SUI	RVEY PLAN (IF DIR	ECTIONALLY C	R HOR	RIZONTALLY DRILLED	D)	торо	OGRAPHICA	AL MAP						
NAME He	ather Calder				TITLE Production Ted	chnician				PHONE 435 646-493	6				
SIGNATU	RE				DATE 07/17/2013					EMAIL hcalder@newfi	eld.com				
	BER ASSIGNED)4753895(0000			APPROVAL				B	DOGULLANDER					
l .									rer	mit ivianagei					

NEWFIELD PRODUCTION COMPANY GMBU D-31-8-18 AT SURFACE: SW/SW SECTION 30, T8S R18E UINTAH COUNTY, UTAH

TEN POINT DRILLING PROGRAM

1. **GEOLOGIC SURFACE FORMATION:**

Uinta formation of Upper Eocene Age

2. <u>ESTIMATED TOPS OF IMPORTANT GEOLOGIC MARKERS:</u>

Uinta 0' - 4,005' Green River 4,005' Wasatch 6,405'

Proposed TD 6,346'(MD) 6,200' (TVD)

3. <u>ESTIMATED DEPTHS OF ANTICIPATED WATER, OIL, GAS OR MINERALS:</u>

Green River Formation (Oil) 4,005' - 6,405'

Fresh water may be encountered in the Uinta Formation, but would not be expected below about 350'. All water shows and water bearing geologic units shall be reported to the geologic and engineering staff of the Vernal Office prior to running the next string of casing or before plugging orders are requested. All water shows must be reported within one (1) business day after being encountered.

All usable (<10,000 PPM TDS) water and prospectively valuable minerals (as described by BLM at onsite) encountered during drilling will be recorded by depth and adequately protected. This information shall be reported to the Vernal Office.

Detected water flows shall be sampled, analyzed, and reported to the geologic & engineering staff of the Vernal Office. The office may request additional water samples for further analysis. Usage of the State of Utah form *Report of Water Encountered* is acceptable, but not required.

The following information is requested for water shows and samples where applicable:

Location & Sampled Interval Date Sampled Flow Rate Temperature

Hardness pH

Water Classification (State of Utah)

Dissolved Calcium (Ca) (mg/l)

Dissolved Sodium (Na) (mg/l)

Dissolved Magnesium (Mg) (mg/l)

Dissolved Bicarbonate (NaHCO₃) (mg/l)

Dissolved Sulfate (SO₄) (mg/l)

Dissolved Total Solids (TDS) (mg/l)

RECEIVED: July 17, 2013

4. <u>PROPOSED CASING PROGRAM</u>

a. Casing Design: GMBU D-31-8-18

Size	Interval		Weight	Grade	Coupling	Design Factors			
Size	Тор	Bottom	weigni	Grade	Coupling	Burst	Collapse	Tension	
Surface casing	0'	300'	24.0	J-55	STC	2,950	1,370	244,000	
8-5/8"		300	24.0	3-33	310	17.53	14.35	33.89	
Prod casing	01	6 0 461	15.5	1.55	1.70	4,810	4,040	217,000	
5-1/2"	0'	6,346'		J-55	LTC	2.38	2.00	2.21	

Assumptions:

- 1) Surface casing max anticipated surface press (MASP) = Frac gradient gas gradient
- 2) Prod casing MASP (production mode) = Pore pressure gas gradient
- 3) All collapse calculations assume fully evacuated casing w/ gas gradient
- 4) All tension calculations assume air weight

Frac gradient at surface casing shoe = 13.0 ppg
Pore pressure at surface casing shoe = 8.33 ppg
Pore pressure at prod casing shoe = 8.33 ppg
Gas gradient = 0.115 psi/ft

All casing shall be new or, if used, inspected and tested. Used casing shall meet or exceed API standards for new casing.

All casing strings shall have a minimum of 1 (one) centralizer on each of the bottom three (3) joints.

b. Cementing Design: GMBU D-31-8-18

Job	Fill	Description	Sacks ft ³	OH Excess*	Weight (ppg)	Yield (ft³/sk)
Surface casing	300'	Class G w/ 2% CaCl	138 161	30%	15.8	1.17
Prod casing	4.346'	Prem Lite II w/ 10% gel + 3%	300	30%	11.0	3.26
Lead	4,340	KCI	979	30%	11.0	3.20
Prod casing	2,000'	50/50 Poz w/ 2% gel + 3%	363	30%	14.3	1.24
Tail	2,000	KCI	451	3076	14.3	1.24

^{*}Actual volume pumped will be 15% over the caliper log

- Compressive strength of lead cement: 1800 psi @ 24 hours, 2250 psi @ 72 hours
- Compressive strength of tail cement: 2500 psi @ 24 hours

Hole Sizes: A 12-1/4" hole will be drilled for the 8-5/8" surface casing. A 7-7/8" hole will be drilled for the 5-1/2" production casing.

The 8-5/8" surface casing shall in all cases be cemented back to surface. In the event that during the primary surface cementing operation the cement does not circulate to surface, or if the cement level should fall back more than 8 feet from surface, then a remedial surface cementing operation shall be performed to insure adequate isolation and stabilization of the surface casing.

5. <u>MINIMUM SPECIFICATIONS FOR PRESSURE CONTROL</u>:

The operator's minimum specifications for pressure control equipment are as follows:

An 8" Double Ram Hydraulic unit with a closing unit will be utilized. Function test of BOP's will be check daily.

Refer to **Exhibit C** for a diagram of BOP equipment that will be used on this well.

6. TYPE AND CHARACTERISTICS OF THE PROPOSED CIRCULATION MUDS:

From surface to ±300 feet will be drilled with an air/mist system. The air rig is equipped with a 6 ½" blooie line that is straight run and securely anchored. The blooie line is used with a discharge less than 100 ft from the wellbore in order to minimize the well pad size. The blooie line is not equipped with an automatic igniter or continuous pilot light and the compressor is located less than 100 ft from the well bore due to the low possibility of combustion with the air dust mixture. The trailer mounted compressor (capacity of 2000 CFM) has a safety shut-off valve which is located 15 feet from the air rig. A truck with 70 bbls of water is on stand by to be used as kill fluid, if necessary. From about ±300 feet to TD, a fresh water system will be utilized. Clay inhibition and hole stability will be achieved with a KCl substitute additive. This additive will be identified in the APD and reviewed to determine if the reserve pit shall be lined. This fresh water system will typically contain Total Dissolved Solids (TDS) of less than 3000 PPM. Anticipated mud weight is 8.4 lbs/gal. If necessary to control formation fluids or pressure, the system will be weighted with the addition of bentonite gel, and if pressure conditions warrant, with barite

No chromate additives will be used in the mud system on Federal and/or Indian lands without prior BLM approval to ensure adequate protection of fresh aquifers.

No chemicals subject to reporting under SARA Title III in an amount equal to or greater than 10,000 pounds will be used, produced, stored, transported, or disposed of annually in association with the drilling, testing, or completing of this well. Furthermore, no extremely hazardous substances, as defined in 40 CFR 355, in threshold planning quantities, will be used, produced, stored, transported, or disposed of in association with the drilling, testing, or completing of this well.

Hazardous substances specifically listed by the EPA as a hazardous waste or demonstrating a characteristic of a hazardous waste will not be used in drilling, testing, or completion operations.

Newfield Production will **visually** monitor pit levels and flow from the well during drilling operations.

7. <u>AUXILIARY SAFETY EQUIPMENT TO BE USED:</u>

Auxiliary safety equipment will be a Kelly Cock, bit float, and a TIW valve with drill pipe threads.

8. <u>TESTING, LOGGING AND CORING PROGRAMS</u>:

The logging program will consist of a Dual Induction, Gamma Ray and Caliper log from TD to base of surface casing @ 300' +/-, and a Compensated Neutron-Formation Density Log from TD to 3500' +-. A cement bond log will be run from PBTD to cement top. No drill stem testing or coring is planned for this well.

9. ANTICIPATED ABNORMAL PRESSURE OR TEMPERATURE:

No abnormal temperatures or pressures are anticipated. No hydrogen sulfide has been encountered or is known to exist from previous drilling in the area at this depth. Maximum anticipated

bottomhole pressure will approximately equal total depth in feet multiplied by a $0.433~\mathrm{psi/foot}$ gradient.

10. <u>ANTICIPATED STARTING DATE AND DURATION OF THE OPERATIONS:</u>

It is anticipated that the drilling operations will commence the fourth quarter of 2013, and take approximately seven (7) days from spud to rig release.

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T8S, R18E, S.L.B.&M. N88°58'05"E - 2646.61' (Meas.) N89°00'19"E - 2567.09' (Meas.) 1910 1910 1910 Brass Cap Brass Cap Brass Cap (Meas. LOT 1 45, 2645. VOO°55'11"W LOT 2 Corner Position Proportioned Using Single Proportion Method (Not Set) 30 1910 Brass Cap WELL LOCATION: LOT 3 D-31-8-18 2651.67 ELEV. EXIST. GRADED GROUND = 4994 LOT 4 Top VOO"52"38"W of Hole 535 Center of Pattern 1910 Spike Brass Cap 240.91 N88°56'07"E - 2639.73' (Meas.) 2580.57' (Meas., N89°02'32"E Brass Cap Bottom of Hole NAD 83 (CENTER OF PATTERN) NAD 83 (SURFACE LOCATION) BASIS OF ELEV; Elevations are based on LATITUDE = 40°04'54.06' LONGITUDE = 109°56'27.01' LATITUDE = $40^{\circ}05'00.60'$ an N.G.S. OPUS Correction. LOCATION: LONGITUDE = $109^{\circ}56'36.82$ LAT. 40°04'09.56" LONG. 110°00'43.28" NAD 27 (CENTER OF PATTERN) NAD 27 (SURFACE LOCATION) LATITUDE = $40^{\circ}04'54.19''$ LATITUDE = $40^{\circ}05'00.74'$ LONGITUDE = $109^{\circ}56'34.29'$ (Tristate Aluminum Cap) Elev. 5281.57'

NEWFIELD EXPLORATION COMPANY

WELL LOCATION, D-31-8-18, LOCATED AS SHOWN IN THE SW 1/4 SW 1/4 (LOT 4) OF SECTION 30, T8S, R18E, S.L.B.&M. UINTAH COUNTY, UTAH.



NOTES:

- Well footages are measured at right angles to the Section Lines.
- 2. Bearings are based on Global Positioning Satellite observations.
- 3. The Center of Pattern footages are 0' FSL & 1300' FWL.



= SECTION CORNERS LOCATED


THIS IS TO CERTIFY THAT THE ABOVE PER WAS PREPARED FROM FIELD NOTES OF ACTUM SURVEYS MADE BY ME OR UNDER MY SUPPRISON AND THAT THE SAME ARE TRUE AND CORRECT TO THE BEST OF MY KNOWLEDGE WAS BOUND BOUND. 189377 OG-11-13 STACY W.


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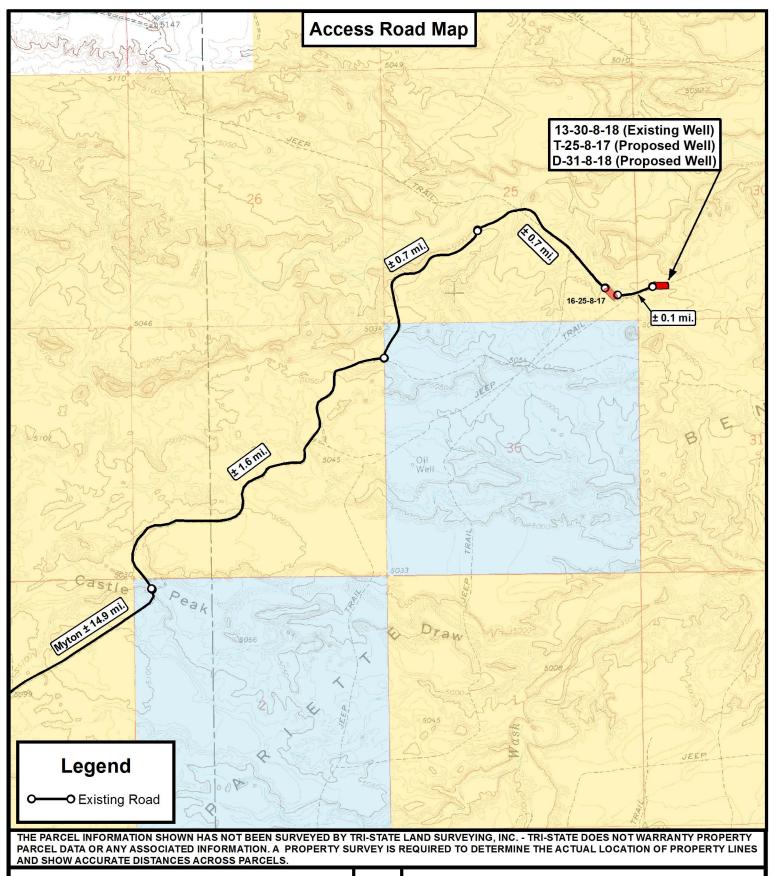
TRI STATE LAND SURVEYING & CONSULTING

180 NORTH VERNAL AVE. - VERNAL, UTAH 84078 (435) 781-2501

	(100) 701 2001	
DATE SURVEYED: 03-08-13	SURVEYED BY: Q.M.	VERSION:
DATE DRAWN: 06-11-13	DRAWN BY: F.T.M.	\/0
REVISED:	SCALE: 1" = 1000'	VZ



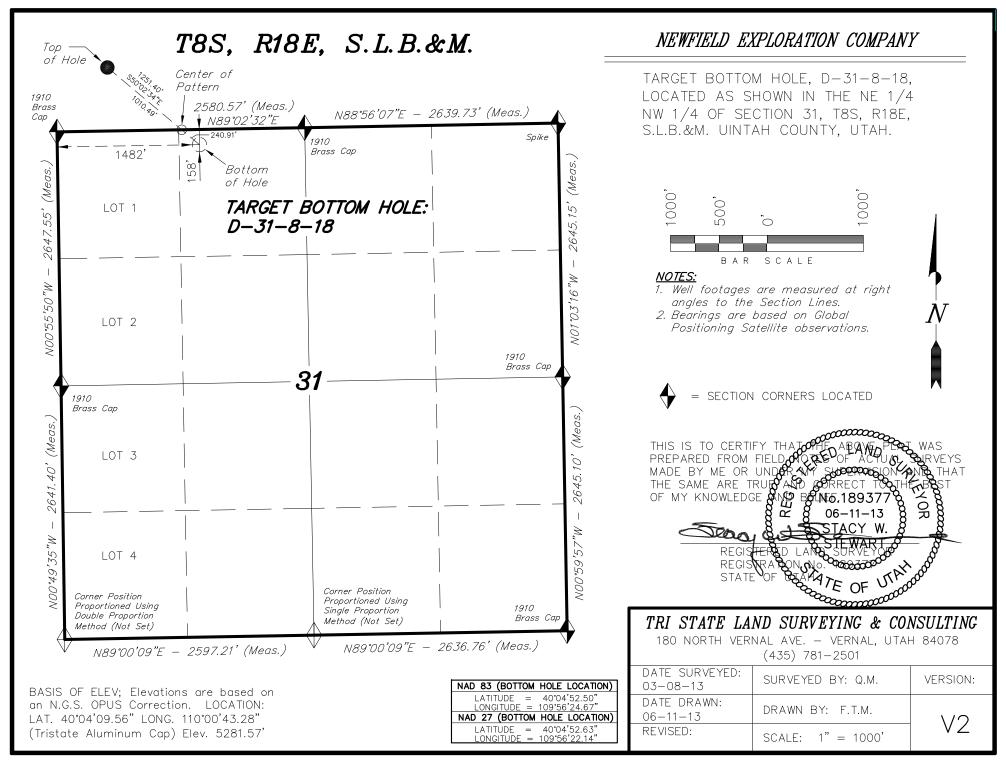

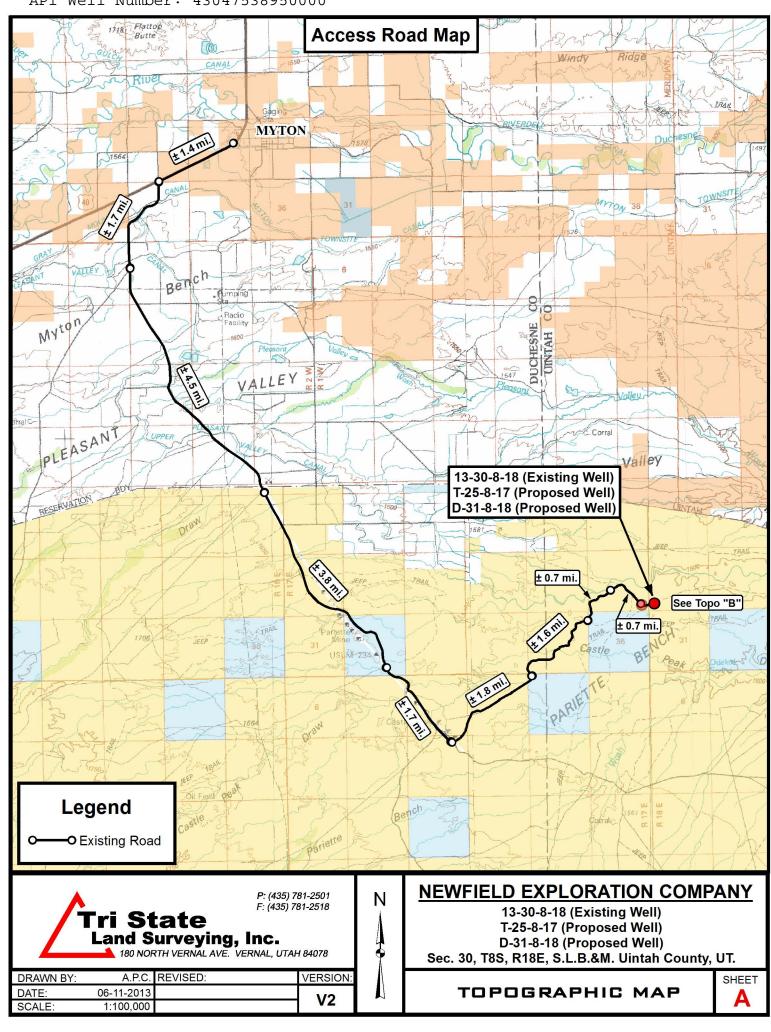



P: (435) 781-2501 F: (435) 781-2518

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180 NORTH VERNAL AVE. VERNAL, UTAH 84078

DRAWN BY:	A.P.C.	REVISED:	VERSION :
DATE:	06-11-2013		V2
SCALE:	1 " = 2,000 '		V Z


NEWFIELD EXPLORATION COMPANY

13-30-8-18 (Existing Well) T-25-8-17 (Proposed Well) D-31-8-18 (Proposed Well)

Sec. 30, T8S, R18E, S.L.B.&M. Uintah County, UT.

TOPOGRAPHIC MAP



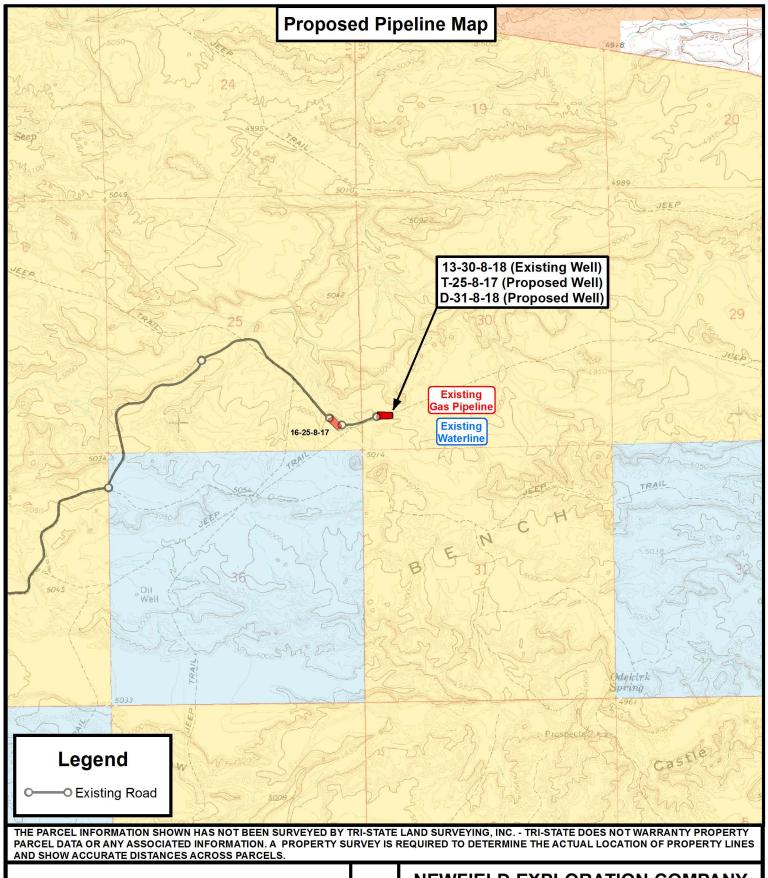

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DATE:

SCALE

A.P.C. | REVISED: | VERSION: 06-11-2013 | V2


NEWFIELD EXPLORATION COMPANY


13-30-8-18 (Existing Well) T-25-8-17 (Proposed Well) D-31-8-18 (Proposed Well)

Sec. 30, T8S, R18E, S.L.B.&M. Uintah County, UT.

TOPOGRAPHIC MAP



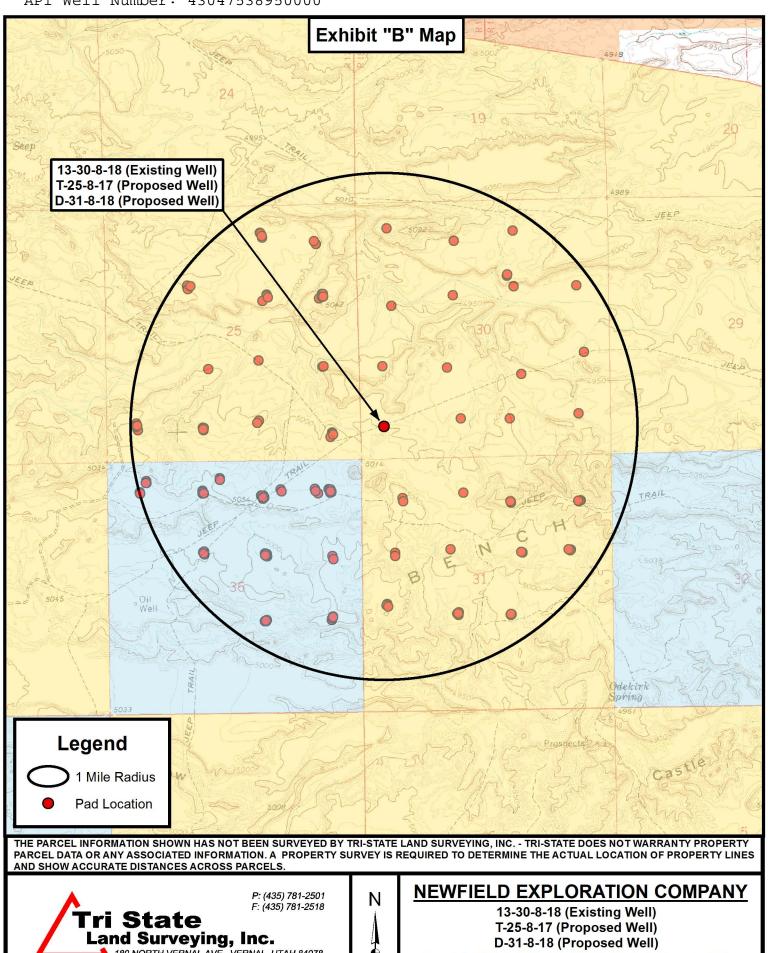

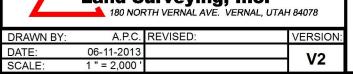

Sec. 30, T8S, R18E, S.L.B.&M. Uintah County, UT.

TOPOGRAPHIC MAP



	Coordin	ate Report	
Well Number	Feature Type	Latitude (NAD 83) (DMS)	Longitude (NAD 83) (DMS)
13-30-8-18	Surface Hole	40° 05' 00.30" N	109° 56' 37.20" W
T-25-8-17	Surface Hole	40° 05' 00.45" N	109° 56' 37.01" W
D-31-8-18	Surface Hole	40° 05' 00.60" N	109° 56' 36.82" W
T-25-8-17	Center of Pattern	40° 05' 06.21" N	109° 56' 44.43" W
D-31-8-18	Center of Pattern	40° 04' 54.06" N	109° 56' 27.01" W
T-25-8-17	Bottom of Hole	40° 05' 07.58" N	109° 56' 46.19" W
D-31-8-18	Bottom of Hole	40° 04' 52.50" N	109° 56' 24.67" W
Well Number	Feature Type	Latitude (NAD 83) (DD)	Longitude (NAD 83) (DD)
13-30-8-18	Surface Hole	40.083417	109.943667
T-25-8-17	Surface Hole	40.083459	109.943615
D-31-8-18	Surface Hole	40.083501	109.943562
T-25-8-17	Center of Pattern	40.085059	109.945675
D-31-8-18	Center of Pattern	40.081683	109.940835
T-25-8-17	Bottom of Hole	40.085440	109.946165
D-31-8-18	Bottom of Hole	40.081250	109.940185
Well Number	Feature Type	Northing (NAD 83) (UTM Meters)	Longitude (NAD 83) (UTM Meter
13-30-8-18	Surface Hole	4437550.377	590059.310
T-25-8-17	Surface Hole	4437555.079	590063.743
D-31-8-18	Surface Hole	4437559.781	590068.177
T-25-8-17	Center of Pattern	4437730.561	589886.018
D-31-8-18	Center of Pattern	4437360.789	590303.037
T-25-8-17	Bottom of Hole	4437772.363	589843.681
D-31-8-18	Bottom of Hole	4437313.348	590359.029
Well Number	Feature Type	Latitude (NAD 27) (DMS)	Longitude (NAD 27) (DMS)
13-30-8-18	Surface Hole	40° 05' 00.44" N	109° 56' 34.67" W
T-25-8-17	Surface Hole	40° 05' 00.59" N	109° 56' 34.48" W
D-31-8-18	Surface Hole	40° 05' 00.74" N	109° 56' 34.29" W
T-25-8-17	Center of Pattern	40° 05' 06.35" N	109° 56' 41.90" W
D-31-8-18	Center of Pattern	40° 04' 54.19" N	109° 56' 24.48" W
T-25-8-17	Bottom of Hole	40° 05' 07.72" N	109° 56' 43.66" W
D-31-8-18	Bottom of Hole	40° 04' 52.63" N	109° 56' 22.14" W



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DATE:	06-11-2013	
VERSION:	V2	

NEWFIELD EXPLORATION COMPANY

13-30-8-18 (Existing Well) T-25-8-17 (Proposed Well) D-31-8-18 (Proposed Well)

Sec. 30, T8S, R18E, S.L.B.&M. Uintah County, UT.

COORDINATE REPORT

SHEET

DATE:

VERSION:

06-11-2013

Latitude (NAD 27) (DD) 40.083455 40.083538 40.085096 40.081721 40.085477 40.081287 Northing (NAD 27) (UTM Meters) 4437345.060 4437349.761 4437354.463 4437155.471 4437567.045 4437108.031	Longitude (NAD 27) (DD) 109.942964 109.942859 109.944972 109.940133 109.945462 109.939483 Longitude (NAD 27) (UTM Meter 590121.554 590125.988 590130.421 589948.262 590365.281 589905.925 590421.273			
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4437567.045	589905.925			
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NEWFIELD EXPLORATION COMPANY 13-30-8-18 (Existing Well) T-25-8-17 (Proposed Well) D-31-8-18 (Proposed Well) Sec. 30, T8S, R18E, S.L.B.&M. Uintah County, UT				
	13-30-8-18 (E T-25-8-17 (Pr D-31-8-18 (Pr			

RECEIVED: July 17, 2013

COORDINATE REPORT



NEWFIELD EXPLORATION

USGS Myton SW (UT) SECTION 30 T8, R18 D-31-8-18

Wellbore #1

Plan: Design #1

Standard Planning Report

10 June, 2013





Payzone Directional

Planning Report



Database: EDM 2003.21 Single User Db Company: NEWFIELD EXPLORATION USGS Myton SW (UT) Site: SECTION 30 T8, R18 Well: D-31-8-18

 Well:
 D-31-8-18

 Wellbore:
 Wellbore #1

 Design:
 Design #1

Local Co-ordinate Reference:

TVD Reference:
MD Reference:
North Reference:

Survey Calculation Method:

Well D-31-8-18

D-31-8-18 @ 5005.0ft (Original Well Elev) D-31-8-18 @ 5005.0ft (Original Well Elev)

True

Minimum Curvature

Project USGS Myton SW (UT), DUCHESNE COUNTY, UT, USA

Map System: US State Plane 1983

Geo Datum: North American Datum 1983

Map Zone: Utah Central Zone

System Datum:

Mean Sea Level

Site SECTION 30 T8, R18

Northing: 7,202,912.37 ft 40° 5' 0.450 N Latitude: Site Position: Lat/Long Easting: 2,075,865.21 ft 109° 56' 37.010 W From: Longitude: **Position Uncertainty:** 0.0 ft Slot Radius: **Grid Convergence:** 1.00°

Well D-31-8-18, SHL LAT: 40 05 00.60 LONG: -109 56 36.82

 Well Position
 +N/-S
 15.2 ft
 Northing:
 7,202,927.80 ft
 Latitude:
 40° 5′ 0.600 N

 +E/-W
 14.8 ft
 Easting:
 2,075,879.72 ft
 Longitude:
 109° 56′ 36.820 W

Wellbore #1 Wellbore Magnetics **Model Name** Sample Date Declination Dip Angle Field Strength (°) (°) (nT) 65.80 IGRF2010 6/10/2013 11.02 52,116

Design	Design #1					
Audit Notes:						
Version:		Phase:	PROTOTYPE	Tie On Depth:	0.0	
Vertical Section:		Depth From (TVD)	+N/-S	+E/-W	Direction	
		(ft)	(ft)	(ft)	(°)	
		0.0	0.0	0.0	129.96	

Plan Sections										
Measured Depth (ft)	Inclination (°)	Azimuth (°)	Vertical Depth (ft)	+N/-S (ft)	+E/-W (ft)	Dogleg Rate (°/100ft)	Build Rate (°/100ft)	Turn Rate (°/100ft)	TFO (°)	Target
0.0	0.00	0.00	0.0	0.0	0.0	0.00	0.00	0.00	0.00	
600.0	0.00	0.00	600.0	0.0	0.0	0.00	0.00	0.00	0.00	
1,511.9	13.68	129.96	1,503.3	-69.6	83.0	1.50	1.50	0.00	129.96	
5,326.8	13.68	129.96	5,210.0	-649.0	774.5	0.00	0.00	0.00	0.00	D-31-8-18 TGT
6,345.7	13.68	129.96	6,200.0	-803.7	959.2	0.00	0.00	0.00	0.00	

RECEIVED: July 17, 2013



Payzone Directional

Planning Report



Database: EDM 2003.21 Single User Db Company: NEWFIELD EXPLORATION Project: USGS Myton SW (UT) Site: SECTION 30 T8, R18

 Well:
 D-31-8-18

 Wellbore:
 Wellbore #1

 Design:
 Design #1

Local Co-ordinate Reference:

TVD Reference:
MD Reference:
North Reference:

Survey Calculation Method:

Well D-31-8-18

D-31-8-18 @ 5005.0ft (Original Well Elev) D-31-8-18 @ 5005.0ft (Original Well Elev)

True

Minimum Curvature

sign:	Design #1									
anned Survey										
Measured Depth (ft)	Inclination (°)	Azimuth (°)	Vertical Depth (ft)	+N/-S (ft)	+E/-W (ft)	Vertical Section (ft)	Dogleg Rate (°/100ft)	Build Rate (°/100ft)	Turn Rate (°/100ft)	
0.0	0.00	0.00	0.0	0.0	0.0	0.0	0.00	0.00	0.00	
100.0	0.00	0.00	100.0	0.0	0.0	0.0	0.00	0.00	0.00	
200.0	0.00	0.00	200.0	0.0	0.0	0.0	0.00	0.00	0.00	
300.0	0.00	0.00	300.0	0.0	0.0	0.0	0.00	0.00	0.00	
400.0	0.00	0.00	400.0	0.0	0.0	0.0	0.00	0.00	0.00	
400.0	0.00	0.00	400.0	0.0	0.0	0.0	0.00	0.00	0.00	
500.0	0.00	0.00	500.0	0.0	0.0	0.0	0.00	0.00	0.00	
600.0	0.00	0.00	600.0	0.0	0.0	0.0	0.00	0.00	0.00	
700.0	1.50	129.96	700.0	-0.8	1.0	1.3	1.50	1.50	0.00	
800.0	3.00	129.96	799.9	-3.4	4.0	5.2	1.50	1.50	0.00	
900.0	4.50	129.96	899.7	-7.6	9.0	11.8	1.50	1.50	0.00	
1,000.0	6.00	129.96	999.3	-13.4	16.0	20.9	1.50	1.50	0.00	
1,100.0	7.50	129.96	1,098.6	-21.0	25.0	32.7	1.50	1.50	0.00	
1,200.0	9.00	129.96	1,197.5	-30.2	36.0	47.0	1.50	1.50	0.00	
1,300.0	10.50	129.96	1,296.1	-41.1	49.0	64.0	1.50	1.50	0.00	
1,400.0	12.00	129.96	1,394.2	-53.6	64.0	83.5	1.50	1.50	0.00	
1.500.0	13.50	129.96	1,491.7	-67.8	80.9	105.5	1.50	1.50	0.00	
1,500.0	13.68	129.96	1,503.3	-67.6 -69.6	83.0	105.5	1.50	1.50	0.00	
			,							
1,600.0	13.68	129.96	1,588.9	-83.0	99.0	129.2	0.00	0.00	0.00	
1,700.0	13.68	129.96	1,686.0	-98.1	117.1	152.8	0.00	0.00	0.00	
1,800.0	13.68	129.96	1,783.2	-113.3	135.3	176.5	0.00	0.00	0.00	
1,900.0	13.68	129.96	1,880.4	-128.5	153.4	200.1	0.00	0.00	0.00	
2,000.0	13.68	129.96	1,977.5	-143.7	171.5	223.8	0.00	0.00	0.00	
			,							
2,100.0	13.68	129.96	2,074.7	-158.9	189.6	247.4	0.00	0.00	0.00	
2,200.0	13.68	129.96	2,171.8	-174.1	207.8	271.1	0.00	0.00	0.00	
2,300.0	13.68	129.96	2,269.0	-189.3	225.9	294.7	0.00	0.00	0.00	
2,400.0	13.68	129.96	2,366.2	-204.5	244.0	318.4	0.00	0.00	0.00	
2,500.0	13.68	129.96	2,463.3	-219.7	262.1	342.0	0.00	0.00	0.00	
2,600.0	13.68	129.96	2,560.5	-234.8	280.3	365.6	0.00	0.00	0.00	
2,700.0	13.68	129.96	2,657.7	-250.0	298.4	389.3	0.00	0.00	0.00	
2,800.0	13.68	129.96	2,754.8	-265.2	316.5	412.9	0.00	0.00	0.00	
2,000.0	13.00	129.90	2,734.0	-205.2	310.3	412.3	0.00	0.00	0.00	
2,900.0	13.68	129.96	2,852.0	-280.4	334.6	436.6	0.00	0.00	0.00	
3,000.0	13.68	129.96	2,949.2	-295.6	352.8	460.2	0.00	0.00	0.00	
3,100.0	13.68	129.96	3,046.3	-310.8	370.9	483.9	0.00	0.00	0.00	
3,200.0	13.68	129.96	3,143.5	-326.0	389.0	507.5	0.00	0.00	0.00	
3,300.0	13.68	129.96	3,240.6	-341.2	407.1	531.2	0.00	0.00	0.00	
3,400.0	13.68	129.96	3,337.8	-356.3	425.3	554.8	0.00	0.00	0.00	
3,500.0	13.68	129.96	3,435.0	-371.5	443.4	578.5	0.00	0.00	0.00	
3,600.0	13.68	129.96	3,532.1	-386.7	461.5	602.1	0.00	0.00	0.00	
3,700.0	13.68	129.96	3,629.3	-401.9	479.7	625.8	0.00	0.00	0.00	
3,800.0	13.68	129.96	3,726.5	-417.1	497.8	649.4	0.00	0.00	0.00	
3,900.0	12 60	129.96	3,823.6	-432.3	E1E 0	672.1	0.00	0.00	0.00	
	13.68				515.9	673.1		0.00		
4,000.0	13.68	129.96	3,920.8	-447.5	534.0	696.7	0.00	0.00	0.00	
4,100.0	13.68	129.96	4,018.0	-462.7	552.2	720.4	0.00	0.00	0.00	
4,200.0	13.68	129.96	4,115.1	-477.8	570.3	744.0	0.00	0.00	0.00	
4,300.0	13.68	129.96	4,212.3	-493.0	588.4	767.7	0.00	0.00	0.00	
4,400.0	13.68	129.96	4,309.4	-508.2	606.5	791.3	0.00	0.00	0.00	
4,500.0	13.68	129.96	4,406.6	-523.4	624.7	815.0	0.00	0.00	0.00	
4,600.0		129.96			642.8					
	13.68		4,503.8	-538.6		838.6	0.00	0.00	0.00	
4,700.0	13.68	129.96	4,600.9	-553.8	660.9	862.3	0.00	0.00	0.00	
4,800.0	13.68	129.96	4,698.1	-569.0	679.0	885.9	0.00	0.00	0.00	
4,900.0	13.68	129.96	4,795.3	-584.2	697.2	909.6	0.00	0.00	0.00	
5,000.0	13.68	129.96	4,892.4	-599.3	715.3	933.2	0.00	0.00	0.00	
5,100.0	13.68	129.96	4,989.6	-614.5	733.4	956.8	0.00	0.00	0.00	
5,200.0							0.00			
5.200.0	13.68	129.96	5,086.8	-629.7	751.5	980.5	0.00	0.00	0.00	



Payzone Directional

Planning Report



Database: Company: Project: Site: EDM 2003.21 Single User Db NEWFIELD EXPLORATION USGS Myton SW (UT) SECTION 30 T8, R18

 Well:
 D-31-8-18

 Wellbore:
 Wellbore #1

 Design:
 Design #1

Local Co-ordinate Reference:

TVD Reference: MD Reference: North Reference:

Survey Calculation Method:

Well D-31-8-18

D-31-8-18 @ 5005.0ft (Original Well Elev) D-31-8-18 @ 5005.0ft (Original Well Elev)

True

Minimum Curvature

lanned Survey									
Measured Depth (ft)	Inclination (°)	Azimuth (°)	Vertical Depth (ft)	+N/-S (ft)	+E/-W (ft)	Vertical Section (ft)	Dogleg Rate (°/100ft)	Build Rate (°/100ft)	Turn Rate (°/100ft)
5,300.0	13.68	129.96	5,183.9	-644.9	769.7	1,004.1	0.00	0.00	0.00
5,326.8	13.68	129.96	5,210.0	-649.0	774.5	1,010.5	0.00	0.00	0.00
5,400.0	13.68	129.96	5,281.1	-660.1	787.8	1,027.8	0.00	0.00	0.00
5,500.0	13.68	129.96	5,378.2	-675.3	805.9	1,051.4	0.00	0.00	0.00
5,600.0	13.68	129.96	5,475.4	-690.5	824.0	1,075.1	0.00	0.00	0.00
5,700.0	13.68	129.96	5,572.6	-705.7	842.2	1,098.7	0.00	0.00	0.00
5,800.0	13.68	129.96	5,669.7	-720.9	860.3	1,122.4	0.00	0.00	0.00
5,900.0	13.68	129.96	5,766.9	-736.0	878.4	1,146.0	0.00	0.00	0.00
6,000.0	13.68	129.96	5,864.1	-751.2	896.5	1,169.7	0.00	0.00	0.00
6,100.0	13.68	129.96	5,961.2	-766.4	914.7	1,193.3	0.00	0.00	0.00
6,200.0	13.68	129.96	6,058.4	-781.6	932.8	1,217.0	0.00	0.00	0.00
6,300.0	13.68	129.96	6,155.6	-796.8	950.9	1,240.6	0.00	0.00	0.00
6,345.7	13.68	129.96	6,200.0	-803.7	959.2	1,251.4	0.00	0.00	0.00

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API Well Number: 43047538950000 Project: USGS Myton SW (UT)




Site: SECTION 30 T8, R18

Well: D-31-8-18 Wellbore: Wellbore #1 Design: Design #1



Azimuths to True North Magnetic North: 11.02°

Magnetic Field Strength: 52115.7snT Dip Angle: 65.80° Date: 6/10/2013 Model: IGRF2010

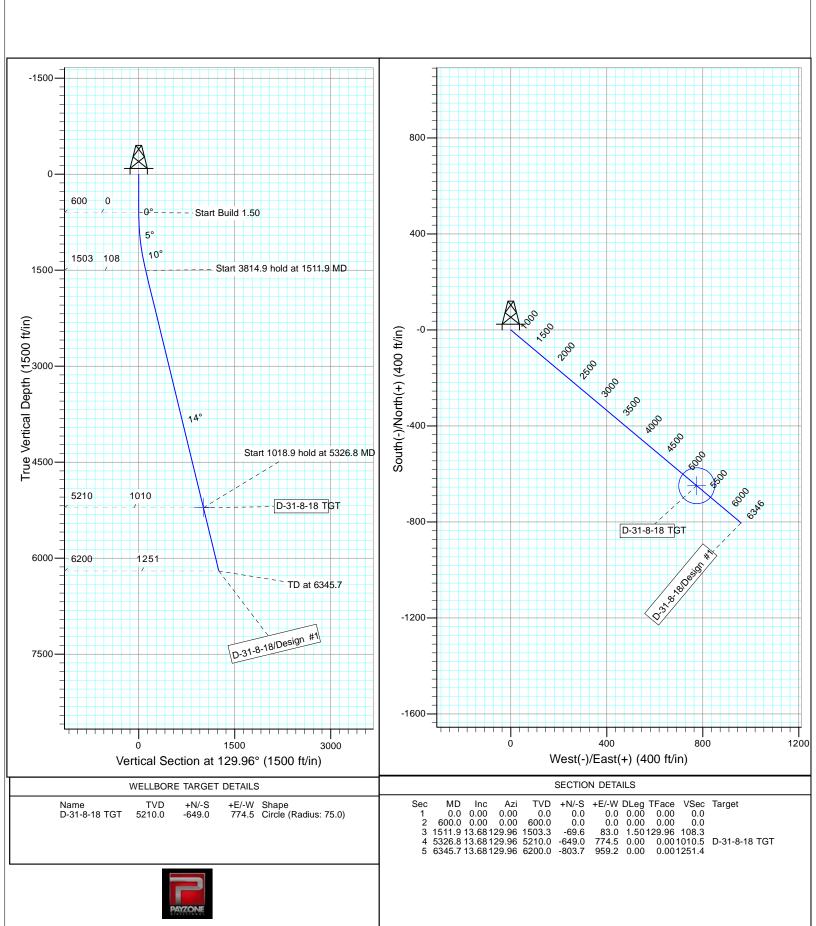

NEWFIELD PRODUCTION COMPANY GMBU D-31-8-18 AT SURFACE: SW/SW SECTION 30, T8S R18E UINTAH COUNTY, UTAH

ONSHORE ORDER NO. 1

MULTI-POINT SURFACE USE & OPERATIONS PLAN

1. EXISTING ROADS

See attached Topographic Map "A"

To reach Newfield Production Company well location site GMBU D-31-8-18 located in the SW 1/4 SW 1/4 Section 30, T8S, R18E, Uintah County, Utah:

Proceed southwesterly out of Myton, Utah along Highway 40-1.4 miles \pm to the junction of this highway and UT State Hwy 53; proceed in a southeasterly direction -11.7 miles \pm to it's junction with an existing road to the east; proceed in a northeasterly direction -4.1 miles \pm to it's junction with an existing road to the east; proceed in a southeasterly direction -0.7 miles \pm to it's junction with the beginning of the access road to the existing 13-30-8-18 well location.

The aforementioned dirt oil field service roads and other roads in the vicinity are constructed out of existing native materials that are prevalent to the existing area they are located in and range from clays to a sandy-clay shale material.

The roads for access during the drilling, completion and production phase will be maintained at the standards required by the State of Utah, or other controlling agencies. This maintenance will consist of some minor grader work for smoothing road surfaces and for snow removal. Any necessary fill material for repair will be purchase and hauled from private sources.

2. PLANNED ACCESS ROAD

There is no proposed access road for this location. The proposed well will be drilled directionaly off of the existing 13-30-8-18 well pad. See attached **Topographic Map "B"**.

There will be **no** culverts required along this access road. There will be barrow ditches and turnouts as needed along this road.

There are no fences encountered along this proposed road. There will be no new gates or cattle guards required.

All construction material for this access road will be borrowed material accumulated during construction of the access road.

3. LOCATION OF EXISTING WELLS

Refer to Exhibit "B".

4. <u>LOCATION OF EXISTING AND/OR PROPOSED FACILITIES</u>

There are no existing facilities that will be used by this well.

It is anticipated that this well will be a producing oil well.

Upon construction of a tank battery, the well pad will be surrounded by a dike of sufficient capacity to contain at minimum 110% of the largest tank volume within the facility battery.

Tank batteries will be built to State specifications.

All permanent (on site for six (6) months or longer) structures, constructed or installed (including pumping units), will be painted a flat, non-reflective, earth tone color to match one of the standard environmental colors, as determined by the Rocky Mountain Five State Interagency Committee. All facilities will be painted within six months of installation.

5. <u>LOCATION AND TYPE OF WATER SUPPLY</u>

Newfield Production will transport water by truck from nearest water source as determined by a Newfield representative for the purpose of drilling the above mentioned well. The available water sources are as follows:

Johnson Water District Water Right: 43-7478

Maurice Harvey Pond Water Right: 47-1358

Neil Moon Pond Water Right: 43-11787

Newfield Collector Well

Water Right: 47-1817 (A30414DVA, contracted with the Duchesne County Conservancy

District).

There will be no water well drilled at this site.

6. SOURCE OF CONSTRUCTION MATERIALS

All construction material for this location shall be borrowed material accumulated during construction of the location site and access road.

A mineral material application is not required for this location.

7. METHODS FOR HANDLING WASTE DISPOSAL

A small reserve pit (90' x 40' x 8' deep, or less) will be constructed from native soil and clay materials. The reserve pit will receive the processed drill cutting (wet sand, shale & rock) removed from the wellbore. Any drilling fluids, which do accumulate in the pit as a result of shale-shaker carryover, cleaning of the sand trap, etc., will be promptly reclaimed. All drilling fluids will be fresh water based, typically containing Total Dissolved Solids of less than 3000 PPM. No potassium chloride, chromates, trash, debris, nor any other substance deemed hazardous will be placed in this pit. Therefore, it is proposed that no synthetic liner be required in the reserve pit. However, if upon constructing the pit there is insufficient fine clay and silt present, a liner will be used for the purpose of reducing water loss through percolation.

Newfield requests approval that a flare pit not be constructed or utilized on this location.

A portable toilet will be provided for human waste.

A trash basket will be provided for garbage (trash) and hauled away to an approved disposal site at the completion of the drilling activities.

8. <u>ANCILLARY FACILITIES</u>

There are no ancillary facilities planned for at the present time and none foreseen in the near future.

9. <u>WELL SITE LAYOUT</u>

See attached Location Layout Sheet.

Fencing Requirements

- All pits will be fenced or have panels installed consistent with the following minimum standards:
 - 1. The wire shall be no more than two (2) inches above the ground. If barbed wire is utilized it will be installed three (3) inches above the net wire. Total height of the fence shall be at least forty-two (42) inches.
 - Corner posts shall be centered and/or braced in such a manner to keep tight and upright at all times
 - 3. Standard steel, wood or pipe posts shall be used between the corner braces. Maximum distance between any two posts shall be no greater than sixteen (16) feet.

The reserve pit fencing will be on three (3) sides during drilling operations and on the fourth side when the rig moves off location. Pits will be fenced and maintained until cleanup.

Existing fences to be crossed by the access road will be braced and tied off before cutting so as to prevent slacking in the wire. The opening shall be closed temporarily as necessary during construction to prevent the escape of livestock, and upon completion of construction the fence shall be repaired to BLM specifications.

10. PLANS FOR RESTORATION OF SURFACE:

a) Producing Location

Immediately upon well completion, the location and surrounding area will be cleared of all unused tubing, equipment, debris, material, trash and junk not required for production.

The reserve pit and that portion of the location not needed for production facilities/operations will be recontoured to the approximated natural contours. Weather permitting, the reserve pit will be reclaimed within one hundred twenty (120) days from the date of well completion. Before any dirt work takes place, the reserve pit must have all fluids and hydrocarbons removed.

b) Dry Hole Abandoned Location

At such time as the well is plugged and abandoned, the operator shall submit a subsequent report of abandonment and the State of Utah will attach the appropriate surface rehabilitation conditions of approval.

11. <u>SURFACE OWNERSHIP</u> – Bureau of Land Management.

12. OTHER ADDITIONAL INFORMATION

The Archaeological Resource Survey and Paleontological Resource Survey for this area are attached. MOAC Report # 13-102 6/14/13, prepared by Montgomery Archaeological Consultants. . Paleontological Resource Survey prepared by, SWCA Environmental Consultants, Report No. UT13-14273-92, May 2013. See attached report cover pages, Exhibit "D".

Water Disposal

After first production, if the production water meets quality guidelines, it will be transported to the Ashley, Monument Butte, Jonah, South Wells Draw and Beluga water injection facilities by company or contract trucks. Subsequently, the produced water is injected into approved Class II wells to enhance Newfield's secondary recovery project. Water not meeting quality criteria, will be disposed at Newfield's Pariette #4 disposal well (Sec. 7, T9S R19E), Federally approved surface disposal facilities or at a State of Utah approved surface disposal facilities.

Additional Surface Stipulations

All lease and/or unit operations will be conducted in such a manner that full compliance is made with all applicable laws and regulations, Onshore Oil and Gas Orders, the approved plan of operations and any applicable Notice to Lessees. A copy of these conditions will be furnished to the field representative to ensure compliance.

Hazardous Material Declaration

Newfield Production Company guarantees that during the drilling and completion of the GMBU D-31-8-18, Newfield will not use, produce, store, transport or dispose 10,000# annually of any of the hazardous chemicals contained in the Environmental Protection Agency's consolidated list of chemicals subject to reporting under Title III Superfund Amendments and Reauthorization Act (SARA) of 1986. Newfield also guarantees that during the drilling and completion of the GMBU D-31-8-18, Newfield will use, produce, store, transport or dispose less than the threshold planning quantity (T.P.Q.) of any extremely hazardous substances as defined in 40 CFR 355.

A complete copy of the approved APD, if applicable, shall be on location during the construction of the location and drilling activities.

Newfield Production Company or a contractor employed by Newfield Production shall contact the State office at (801) 722-3417, 48 hours prior to construction activities.

13. <u>LESSEE'S OR OPERATOR'S REPRENSENTATIVE AND CERTIFICATION:</u>

Representative

Name: Corie Miller

Address: Newfield Production Company

Route 3, Box 3630 Myton, UT 84052

Telephone: (435) 646-3721


Certification

Please be advised that NEWFIELD PRODUCTION COMPANY is considered to be the operator of well #D-31-8-18, Section 30, Township 8S, Range 18E: Lease UTU-75532 Uintah County, Utah: and is responsible under the terms and conditions of the lease for the operations conducted upon the leased lands. Bond coverage is provided by, Federal Bond #WYB000493.

I hereby certify that the proposed drill site and access route have been inspected, and I am familiar with the conditions which currently exist; that the statements made in this plan are true and correct to the best of my knowledge; and that the work associated with the operations proposed here will be performed by Newfield Production Company and its contractors and subcontractors in conformity with this plan and the terms and conditions under which it is approved. This statement is subject to the provisions of the 18 U.S.C. 1001 for the filing of a false statement.


7/17/13	
Date	Heather Calder
	Production Technician
	Newfield Production Company


Typical 2M BOP stack configuration

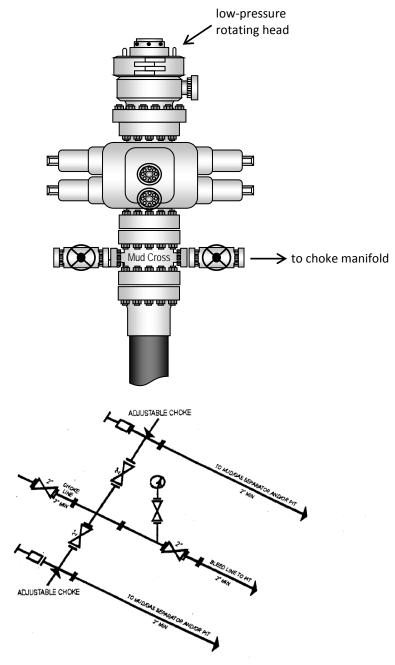

2M CHOKE MANIFOLD EQUIPMENT - CONFIGURATION OF CHOKES MAY VARY

NEWFIELD EXPLORATION COMPANY TOP HOLE FOOTAGES CENTER OF WELL PAD INTERFERENCE PLAT T-25-8-17 PATTERN FOOTAGES 647' FSL & 521' FWL 13-30-8-18 (Existing Well) T-25-8-17 D-31-8-181229' FSL & 57' FEL T-25-8-17 (Proposed Well) 662' FSL & 535' FWL D-31-8-18D-31-8-18 (Proposed Well) 0' FSL & 1300' FWL Pad Location: SWSW (LOT 4) Section 30, T8S, R18E, S.L.B.&M. LATITUDE & LONGITUDE Surface position of Wells (NAD 83) BOTTOM HOLE FOOTAGES T-25-8-17 WELL LATITUDE LONGITUDE 1368' FSL & 195' FEL Existing 13-30-8-18 | 40° 05' 00.30" 109° 56′ 37.20″ D-.31-8-18Stockpile T-25-8-17 | 40° 05' 00.45" 109° 56′ 37.01″ 158' FNL & 1482' FWL D-31-8-1840° 05' 00.60" 109° 56′ 36.82″ LATITUDE & LONGITUDE Center of Pattern (NAD 83) Edge of Existing Pad WFII LATITUDE LONGITUDE T-25-8-17 40° 05' 06.21" 109° 56′ 44.43″ Existina Anchor 40° 04′ 54.06″ 109° 56′ 27.01″ (Typ.) D-31-8-18D-31-8-18 (PROPOSED)T-25-8-17 (PROPOSED)13-30-8-18 (EXISTING) is Note: Existing Access Road Bearings are N88°00'02"E based on GPS Observations. Boiler Existing RELATIVE COORDINATES From Top Hole to C.O.P. Proposed Pit WELL NORTH EAST T-25-8-17 573 -587 LATITUDE & LONGITUDE -649'775 D-31-8-18Bottom Hole Position (NAD 83) WELL LATITUDE LONGITUDE RELATIVE COORDINATES T-25-8-17 40° 05' 07.58" 109° 56′ 46.19″ From Top Hole to Bottom Hole D-31-8-18 40° 04' 52.50" 109° 56' 24.67" NORTH WELL EAST $Tri\ S\overline{tate}$ SURVEYED BY: Q.M. DATE SURVEYED: 03-08-13 **VERSION:** (435) 781-2501 T-25-8-17 709 -726 DRAWN BY: F.T.M. DATE DRAWN: 06-11-13 Land Surveying, Inc. 180 NORTH VERNAL AVE. VERNAL, UTAH 84078 V2 D-31-8-18-804'959 1" = 60'SCALE: REVISED:

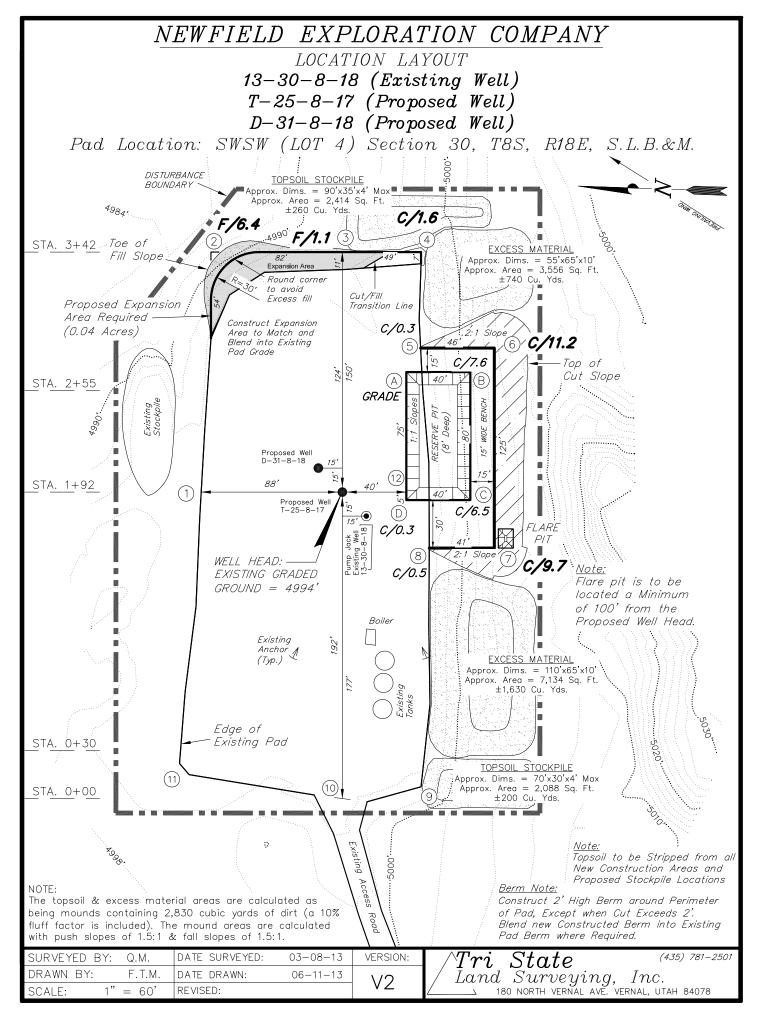

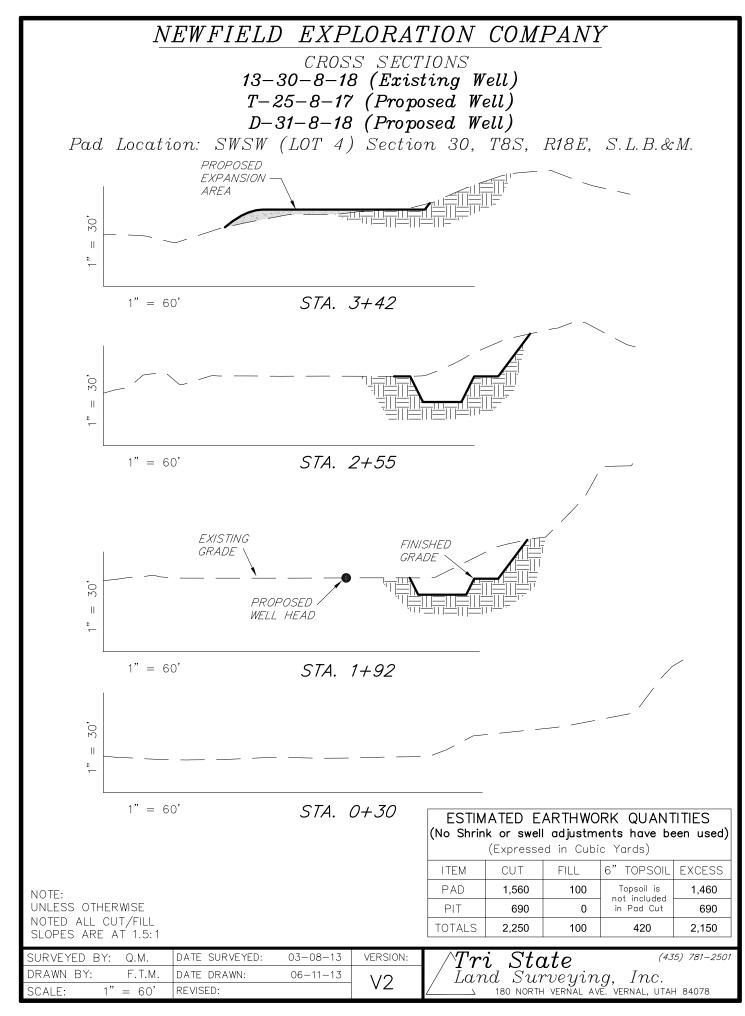

NEWFIELD EXPLORATION COMPANY TYPICAL RIG LAYOUT 13-30-8-18 (Existing Well) T-25-8-17 (Proposed Well) D-31-8-18 (Proposed Well) Pad Location: SWSW (LOT 4) Section 30, T8S, R18E, S.L.B.&M. STORAGE YELLOW DOG 135' 46' BOILER 5, PUMP PUMP RESERVE PIT (8' Deep) HOUSE MUD PARTS 15'® 30, Existing Well 13-30-8-18 PIPE RACKS FLARE PIPE RACKS Flare pit is to be ☐ TOILET located a Minimum of 100' from the Proposed Well Head. 192' $State \ Surveying, Inc.$ 180 north vernal ave. vernal, utah 84078 SURVEYED BY: Q.M. DATE SURVEYED: 03-08-13 VERSION: Tri(435) 781-2501 DRAWN BY: F.T.M. DATE DRAWN: 06-11-13 LandV2 SCALE: 1" = 60'REVISED:

NEWFIELD EXPLORATION COMPANY RECLAMATION LAYOUT 13-30-8-18 (Existing Well) T-25-8-17 (Proposed Well) D-31-8-18 (Proposed Well) Pad Location: SWSW (LOT 4) Section 30, T8S, R18E, S.L.B.&M. DISTURBANCE Reclaimed Area BOUNDARY D-31-8-18 () T-25-8-17 💿 13-30-8-18 Proposed Unreclaimed Area Reclaimed Area DISTURBED AREA: 1. Reclaimed Area to Include Seeding of Approved Vegetation TOTAL DISTURBED AREA = ± 2.29 ACRES and Sufficient Storm Water Management System. TOTAL RECLAIMED AREA = ± 1.68 ACRES 2. Actual Equipment Layout and Reclaimed Pad Surface Area May Change due to Production Requirements or Site Conditions. UNRECLAIMED AREA $= \pm 0.61$ ACRES $Tri~State~^{ ext{(4.35)}}$ 781-.Land~Surveying,~Inc.DATE SURVEYED: 03-08-13 (435) 781-2501 SURVEYED BY: Q.M. VERSION: DRAWN BY: F.T.M. DATE DRAWN: 06-11-13 SCALE: 1" = 60'REVISED:

NEWFIELD EXPLORATION COMPANY


PROPOSED SITE FACILITY DIAGRAM

13-30-8-18 UTU-75532

T-25-8-17 UTU-75532

D-31-8-18 UTU-75532


Pad Location: SWSW (LOT 4) Section 30, T8S, R18E, S.L.B.&M. Uintah County, Utah

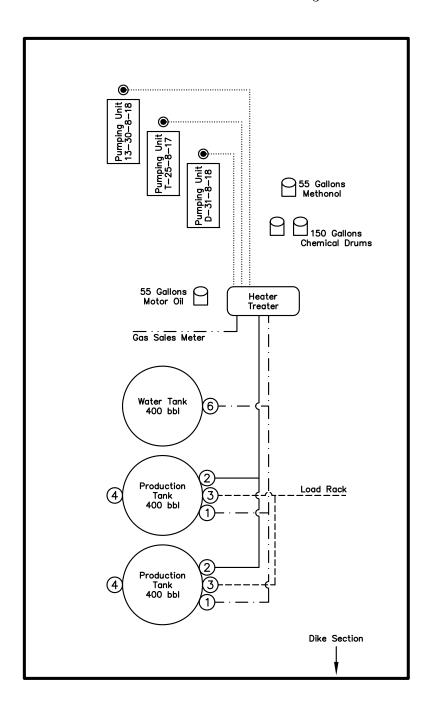

\underline{Legend}

NOT TO SCALE

SURVEYED BY:	Q.M.	DATE SURVEYED:	03-08-13	VERSION:	$\wedge Tri$ $State$ (435) 781–2501
DRAWN BY:	F.T.M.	DATE DRAWN:	06-11-13	1/2	/ Land Surveying, Inc.
SCALE:	NONE	REVISED:		٧Z	180 NORTH VERNAL AVE. VERNAL, UTAH 84078

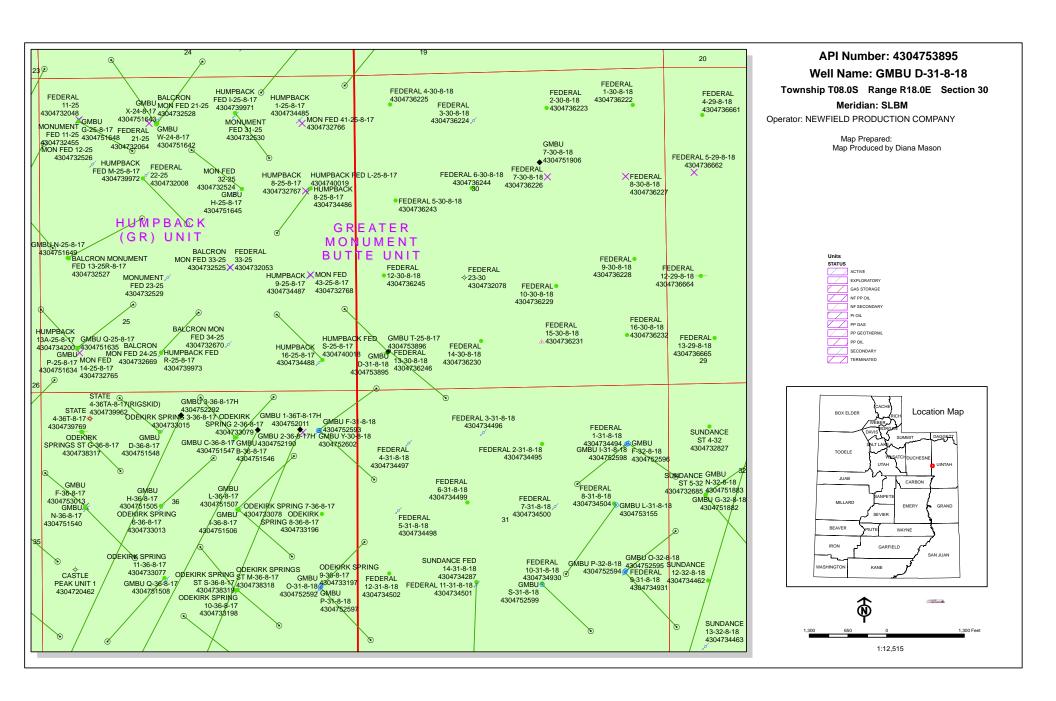

United States Department of the Interior

BUREAU OF LAND MANAGEMENT

Utah State Office 440 West 200 South, Suite 500 Salt Lake City, UT 84101

IN REPLY REFER TO: 3160 (UT-922)

July 22, 2013

Memorandum

To: Assistant Field Office Manager Minerals,

Vernal Field Office

From: Michael Coulthard, Petroleum Engineer

Subject: 2013 Plan of Development Greater Monument

Butte Unit, Duchesne and Uintah Counties,

Utah.

Pursuant to email between Diana Whitney, Division of Oil, Gas and Mining, and Mickey Coulthard, Utah State Office, Bureau of Land Management, the following wells are planned for calendar year 2013 within the Greater Monument Butte Unit, Duchesne and Uintah Counties, Utah.

API # WELL NAME LOCATION

(Proposed PZ GREEN RIVER)

43-013-52310 GMBU N-27-8-17 Sec 27 T08S R17E 1890 FSL 1905 FWL BHL Sec 27 T08S R17E 2412 FNL 1218 FWL

43-013-52311 GMBU R-27-8-17 Sec 27 T08S R17E 1874 FSL 1919 FWL

BHL Sec 27 T08S R17E 1157 FSL 2490 FEL

43-013-52312 GMBU C-3-9-17 Sec 03 T09S R17E 0975 FNL 1618 FEL

BHL Sec 03 T09S R17E 0102 FNL 2381 FWL

43-013-52313 GMBU H-3-9-17 Sec 03 T09S R17E 0995 FNL 1626 FEL

BHL Sec 03 T09S R17E 1308 FNL 2624 FEL

43-013-52314 GMBU W-3-9-17 Sec 10 T09S R17E 0679 FNL 1965 FEL

BHL Sec 03 T09S R17E 0170 FSL 2532 FWL

43-013-52315 GMBU H-10-9-17 Sec 10 T09S R17E 0697 FNL 1954 FEL

BHL Sec 10 T09S R17E 1629 FNL 2636 FEL

43-047-53895 GMBU D-31-8-18 Sec 30 T08S R18E 0662 FSL 0535 FWL

BHL Sec 31 T08S R18E 0158 FNL 1482 FWL

RECEIVED: July 23, 2013

Page 2

API # WELL NAME LOCATION

(Proposed PZ GREEN RIVER)

43-047-53896 GMBU T-25-8-17 Sec 30 T08S R18E 0647 FSL 0521 FWL BHL Sec 25 T08S R17E 1368 FSL 0195 FEL 43-047-53897 GMBU G-1-9-17 Sec 01 T09S R17E 0679 FNL 1981 FWL BHL Sec 01 T09S R17E 1460 FNL 1392 FWL Sec 01 T09S R17E 0699 FNL 1988 FWL 43-047-53898 GMBU H-1-9-17 BHL Sec 01 T09S R17E 1427 FNL 2543 FEL 43-047-53899 GMBU M-1-9-17 Sec 01 T09S R17E 1555 FSL 1840 FEL BHL Sec 01 T09S R17E 2600 FNL 2602 FWL 43-047-53901 GMBU V-34-8-18 Sec 03 T09S R18E 0779 FNL 0671 FEL BHL Sec 34 T08S R18E 0202 FSL 1495 FEL 43-047-53902 GMBU E-2-9-18 Sec 03 T09S R18E 0791 FNL 0654 FEL BHL Sec 02 T09S R18E 0011 FNL 0322 FWL

This office has no objection to permitting the wells at this time.

Michael L. Coulthard

Digitally signed by Michael L. Coulthard

DN: cn=Michael L. Coulthard, o=Bureau of Land Management,
ou=Branch of Minerals, email=Michael_Coulthard@blm.gov, c=US
Date: 2013.07.22 15:52:46-06'00'

bcc: File - Greater Monument Butte Unit Division of Oil Gas and Mining Central Files Agr. Sec. Chron Fluid Chron

MCoulthard:mc:7-22-13

WORKSHEET APPLICATION FOR PERMIT TO DRILL

APD RECEIVED: 7/17/2013 API NO. ASSIGNED: 43047538950000

WELL NAME: GMBU D-31-8-18

OPERATOR: NEWFIELD PRODUCTION COMPANY (N2695) **PHONE NUMBER:** 435 646-4936

CONTACT: Heather Calder

PROPOSED LOCATION: SWSW 30 080S 180E Permit Tech Review:

> SURFACE: 0662 FSL 0535 FWL **Engineering Review:**

> **BOTTOM:** 0158 FNL 1482 FWL Geology Review:

COUNTY: UINTAH

LATITUDE: 40.08339 LONGITUDE: -109.94348

UTM SURF EASTINGS: 590076.00 NORTHINGS: 4437547.00

FIELD NAME: EIGHT MILE FLAT LEASE TYPE: 1 - Federal

LEASE NUMBER: UTU-75532 PROPOSED PRODUCING FORMATION(S): GREEN RIVER

SURFACE OWNER: 1 - Federal **COALBED METHANE: NO**

RECEIVED AND/OR REVIEWED: ✓ PLAT	LOCATION AND SITING: R649-2-3.
■ Bond: FEDERAL - WYB000493	Unit: GMBU (GRRV)
Potash	R649-3-2. General
Oil Shale 190-5	
Oil Shale 190-3	R649-3-3. Exception
Oil Shale 190-13	✓ Drilling Unit
✓ Water Permit: 437478	Board Cause No: Cause 213-11
RDCC Review:	Effective Date: 11/30/2009
Fee Surface Agreement	Siting: Suspends General Siting
Intent to Commingle	✓ R649-3-11. Directional Drill

Comments: Presite Completed

Commingling Approved

4 - Federal Approval - dmason 15 - Directional - dmason Stipulations:

27 - Other - bhill

RECEIVED: July 25, 2013



State of Utah

DEPARTMENT OF NATURAL RESOURCES

MICHAEL R. STYLER
Executive Director

Division of Oil, Gas and Mining

JOHN R. BAZA
Division Director

Permit To Drill

Well Name: GMBU D-31-8-18 **API Well Number:** 43047538950000

Lease Number: UTU-75532 Surface Owner: FEDERAL Approval Date: 7/25/2013

Issued to:

NEWFIELD PRODUCTION COMPANY, Rt 3 Box 3630, Myton, UT 84052

Authority:

Pursuant to Utah Code Ann. 40-6-1 et seq., and Utah Administrative Code R649-3-1 et seq., the Utah Division of Oil, Gas and Mining issues conditions of approval, and permit to drill the listed well. This permit is issued in accordance with the requirements of Cause 213-11. The expected producing formation or pool is the GREEN RIVER Formation(s), completion into any other zones will require filing a Sundry Notice (Form 9). Completion and commingling of more than one pool will require approval in accordance with R649-3-22.

Duration:

This approval shall expire one year from the above date unless substantial and continuous operation is underway, or a request for extension is made prior to the expiration date

General:

Compliance with the requirements of Utah Admin. R. 649-1 et seq., the Oil and Gas Conservation General Rules, and the applicable terms and provisions of the approved Application for permit to drill.

Conditions of Approval:

State approval of this well does not supercede the required federal approval, which must be obtained prior to drilling.

In accordance with Utah Admin. R.649-3-11, Directional Drilling, the operator shall submit a complete angular deviation and directional survey report to the Division within 30 days following completion of the well.

Production casing cement shall be brought up to or above the top of the unitized interval for the Greater Monument Butte Unit (Cause No. 213-11).

Notification Requirements:

The operator is required to notify the Division of Oil, Gas and Mining of the following actions during drilling of this well:

• Within 24 hours following the spudding of the well - contact Carol Daniels at 801-538-5284

(please leave a voicemail message if not available) OR

submit an electronic sundry notice (pre-registration required) via the Utah Oil & Gas website

at http://oilgas.ogm.utah.gov

Reporting Requirements:

All reports, forms and submittals as required by the Utah Oil and Gas Conservation General Rules will be promptly filed with the Division of Oil, Gas and Mining, including but not limited to:

- Entity Action Form (Form 6) due within 5 days of spudding the well
- Monthly Status Report (Form 9) due by 5th day of the following calendar month
 - Requests to Change Plans (Form 9) due prior to implementation
 - Written Notice of Emergency Changes (Form 9) due within 5 days
- Notice of Operations Suspension or Resumption (Form 9) due prior to implementation
 - Report of Water Encountered (Form 7) due within 30 days after completion
- Well Completion Report (Form 8) due within 30 days after completion or plugging

Approved By:

For John Rogers Associate Director, Oil & Gas



VIA ELECTRONIC DELIVERY

Newfield Exploration Company

1001 17th Street | Suite 2000 Denver, Colorado 80202 PH 303-893-0102 | FAX 303-893-0103

July 29, 2013

State of Utah, Division of Oil, Gas and Mining ATTN: Diana Mason P.O. Box 145801 Salt Lake City, UT 84114-5801

RE:

Directional Drilling

GMBU D-31-8-18

Greater Monument Butte (Green River) Unit

Surface Hole:

T8S-R18E Section 30: Lot 4 (SWSW) (UTU-75532)

662' FSL 535' FWL

At Target:

T8S-R18E Section 31: NENW (UTU-74872)

158' FNL 1482' FWL

Uintah County, Utah

Dear Ms. Mason:

Pursuant to the filing by Newfield Production Company (NPC) of an Application for Permit to Drill the above referenced well dated 7/18/2013, a copy of which is attached, and in accordance with Oil and Gas Conservation Rule R649-3-11, NPC hereby submits this letter as notice of our intention to directionally drill this well.

The surface hole and target locations of this well are both within the boundaries of the Greater Monument Butte Unit (UTU-87538X), of which Newfield certifies that it is the operator. Further, Newfield certifies that all lands within 460 feet of the entire directional well bore are within the Greater Monument Butte Unit.

NPC is permitting this well as a directional well in order to mitigate surface disturbance by utilizing preexiting roads and pipelines.

NPC hereby requests our application for permit to drill be granted pursuant to R649-3-11. If you have any questions or require further information, please contact the undersigned at 303-383-4121 or by email at lburget@newfield.com. Your consideration in this matter is greatly appreciated.

Sincerely,

Newfield Production Company

Holi Burget

Leslie Burget Land Associate

FORM APPROVED

(August 2007) UNITED S DEPARTMENT OF BUREAU OF LAND	OMB No. 100 Expires July 3 5. Lease Serial No. UTU75532	04-0136		
APPLICATION FOR PERMIT	TO DRILL OR REENTER	6. If Indian, Allottee or Tribe	Name	
1a. Type of Work: ☑ DRILL ☐ REENTER		7. If Unit or CA Agreement, GMBU	Name and No.	
1b. Type of Well: ☑ Oil Well ☐ Gas Well ☐ Other ☑ Single Zone ☐ Multiple Zone		8. Lease Name and Well No. GMBU D-31-8-18		
	: HEATHER CALDER r@newfield.com	9. API Well No.		
3a. Address ROUTE 3 BOX 3630 MYTON, UT 84052	3b. Phone No. (include area code) Ph: 435-646-4936 Fx: 435-646-3031		10. Field and Pool, or Exploratory MONUMENT BUTTE	
4. Location of Well (Report location clearly and in accord	ance with any State requirements.*)	11. Sec., T., R., M., or Blk. a	and Survey or Area	
At surface SWSW 662FSL 535FWL		Sec 30 T8S R18E Me	er SLB	
At proposed prod. zone NENW 158FNL 1482FWL				
14. Distance in miles and direction from nearest town or pos 18 MILES SOUTH OF MYTON, UT	office*	12. County or Parish UINTAH	13. State UT	
15. Distance from proposed location to nearest property or lease line, ft. (Also to nearest drig, unit line, if any)			17. Spacing Unit dedicated to this well	
158'	1434.00	20.00		
18. Distance from proposed location to nearest well, drilling,	19. Proposed Depth	20. BLM/BIA Bond No. on	20. BLM/BIA Bond No. on file	
completed, applied for, on this lease, ft.	6346 MD 6200 TVD	WYB000493		
21. Elevations (Show whether DF, KB, RT, GL, etc. 4994 GL 22. Approximate date work will start 09/01/2013		23. Estimated duration 7 DAYS		
	24. Attachments			
The following, completed in accordance with the requirements	of Onshore Oil and Gas Order No. 1, shall be attached to	this form:		
Well plat certified by a registered surveyor. A Drilling Plan. A Surface Use Plan (if the location is on National Forest Sy SUPO shall be filed with the appropriate Forest Service Company of the Property Sur	stem Lands, the Item 20 above). 5. Operator certification	ons unless covered by an existing formation and/or plans as may be		
25. Signature (Electronic Submission)	Name (Printed/Typed) Date HEATHER CALDER Ph: 435-646-4936 07/18		Date 07/18/2013	
Title PRODUCTION TECHNICIAN				
Approved by (Signature)	Name (Printed/Typed)		Date	
Title	Office			
Application approval does not warrant or certify the applicant loperations thereon.	lolds legal or equitable title to those rights in the subject l	ease which would entitle the app	licant to conduct	


Conditions of approval, if any, are attached. Title 18 U.S.C. Section 1001 and Title 43 U.S.C. Section 1212, make it a crime for any person knowingly and willfully to make to any department or agency of the United States any false, fictitious or fraudulent statements or representations as to any matter within its jurisdiction.

Additional Operator Remarks (see next page)

Electronic Submission #213993 verified by the BLM Well Information System For NEWFIELD EXPLORATION, sent to the Vernal

Additional Operator Remarks:

SURFACE HOLE LEASE:UTU75532 BOTTOM HOLE LEASE:UTU74872

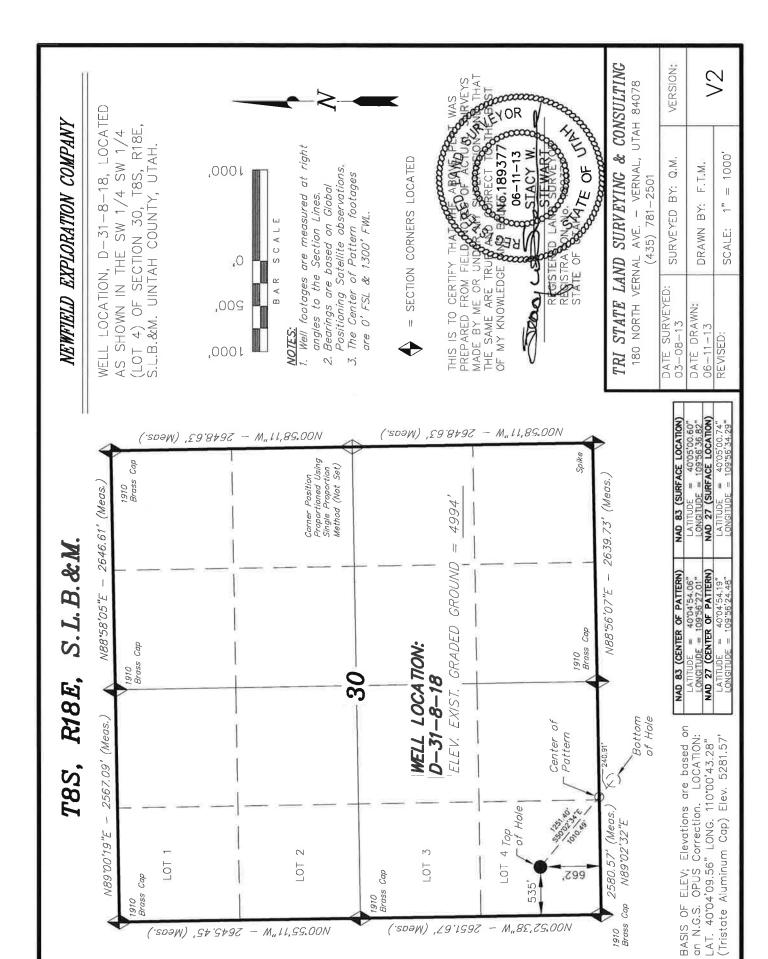

7

LOT

- M., 11,59.00N

J., 61, 00.68N

LOT

5645,45' (Meds.)

1910 Brass Cap

\$ 37/4 \$ 100

,799

2580.57' (Meas. N89°02'32"E

1910 Brass Cap

of Hole

- M.,88,79.00N


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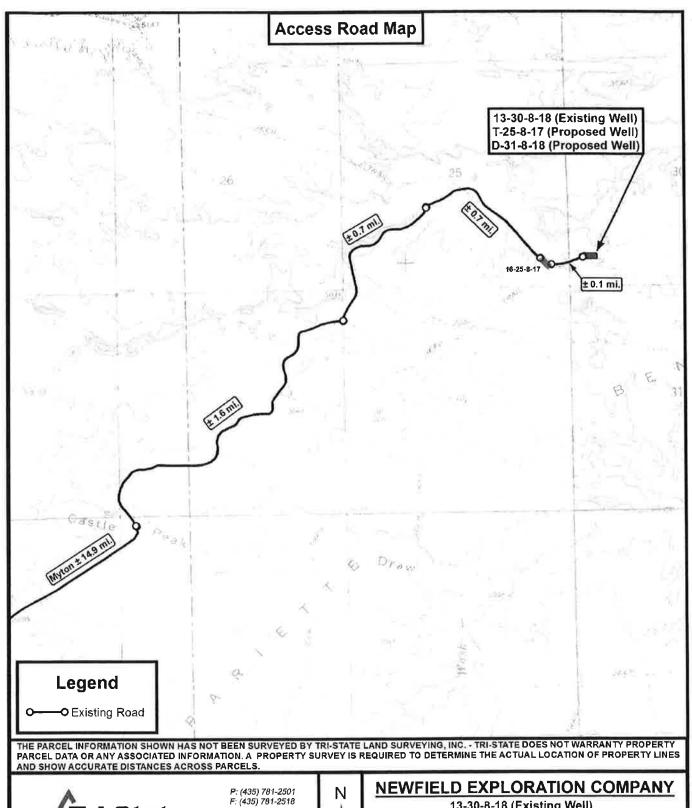
M

LO

2651.67' (Meds.)

1910 Brass Cap



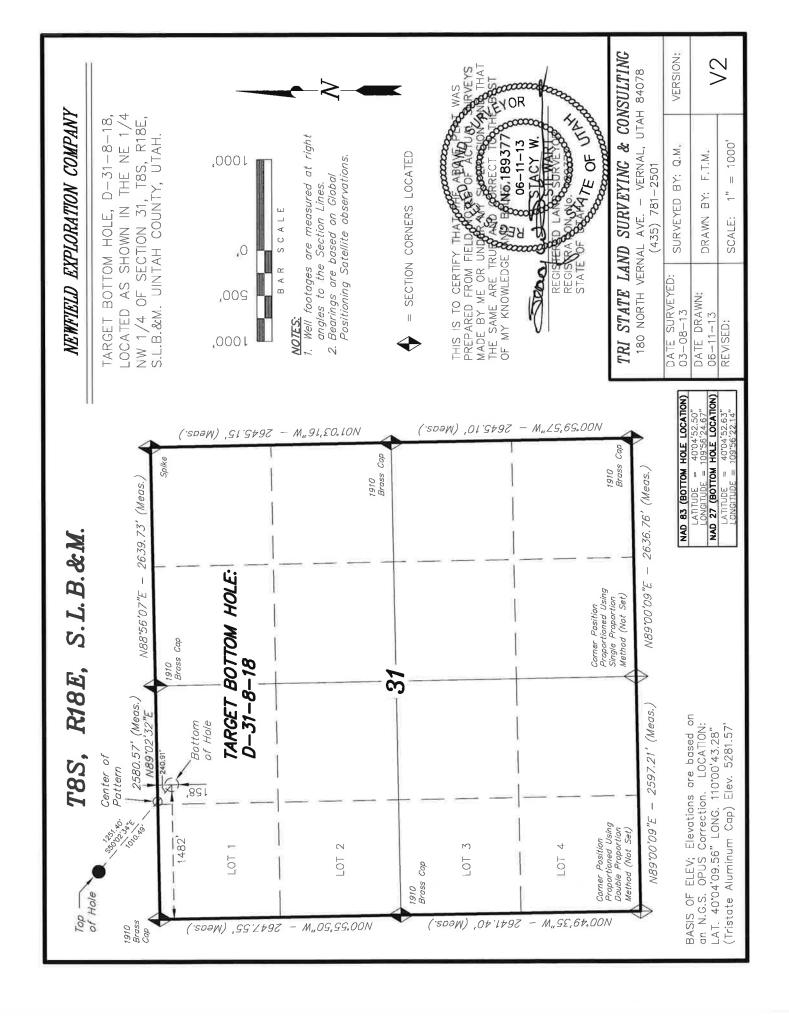



DRAWN BY:	A.P.C.	REVISED:	VERSION:
DATE:	06-11-2013		V2
SCALE:	1"= 2,000"		V2



13-30-8-18 (Existing Well) T-25-8-17 (Proposed Well) D-31-8-18 (Proposed Well)

Sec. 30, T8S, R18E, S.L.B.&M. Uintah County, UT.

TOPOGRAPHIC MAP

SHEET

Form 3160-3 (August 2007)

RECEIVED

UNITED STATES DEPARTMENT OF THE INTERIOR **BUREAU OF LAND MANAGEMENT** JUL 2 2 2013

FORM APPROVED OMB No. 1004-0136

APPLICATION FOR PERMIT TO DRILL OR REF

Expires July 31, 2010

5. Lease Serial No. UTU75532

APPLICATION FOR PERMIT	TO DRILL OR REENTER	6. If Indian, Allottee or Tri	be Name
la. Type of Work: DRILL REENTER		7. If Unit or CA Agreemen UTU87538X	at, Name and No.
1b. Type of Well: ☑ Oil Well ☐ Gas Well ☐ Ot	her Single Zone Multiple Zone	8. Lease Name and Well N GMBU D-31-8-18	O.
2. Name of Operator Contact: NEWFIELD EXPLORATION COMPANN: hcalder	HEATHER CALDER	9. API Well No. 43047538	·0<
3a. Address ROUTE 3 BOX 3630 MYTON, UT 84052	3b. Phone No. (include area code) Ph: 435-646-4936 Fx: 435-646-4936	10. Field and Pool, or Expl MONUMENT BUTT	oratory
4. Location of Well (Report location clearly and in accorded	ance with any State requirements.*)	11. Sec., T., R., M., or Blk.	and Survey or Area
At surface Lot 4 662FSL 535FWL 40.	050060 N Lat, 109.563682 W Lon	Sec 30 T8S R18E M	-
At proposed prod. zone NENW 158FNL 1482FWL	40.045250 N Lat, 109.562467 W Lon	SME: BLM	IEI SLD
 Distance in miles and direction from nearest town or post MILES SOUTH OF MYTON, UT 	office*	12. County or Parish UINTAH	13. State UT
 Distance from proposed location to nearest property or lease line, ft. (Also to nearest drig. unit line, if any) 	16. No. of Acres in Lease	17. Spacing Unit dedicated	to this well
158'	1434.04	20.00	
 Distance from proposed location to nearest well, drilling, completed, applied for, on this lease, ft. 	19. Proposed Depth	20. BLM/BIA Bond No. on	file
1179'	6346 MD 6200 TVD	WYB000493	
 Elevations (Show whether DF, KB, RT, GL, etc. 4994 GL 	22. Approximate date work will start 09/01/2013	23. Estimated duration 7 DAYS	CEIVED
	24. Attachments	MAY	2 7 2014
he following, completed in accordance with the requirements of	Onshore Oil and Gas Order No. 1, shall be attached to the	nis form:	
 Well plat certified by a registered surveyor. A Drilling Plan. A Surface Use Plan (if the location is on National Forest Syste SUPO shall be filed with the appropriate Forest Service Off 	4. Bond to cover the operation Item 20 above). 5. Operator certification	ns unless covered by an existing	
25. Signature (Electronic Submission)	Name (Printed/Typed) HEATHER CALDER Ph: 435-646-4936		Date 07/18/2013
Title PRODUCTION TECHNICIAN			
Approved by (Signature)	Name (Printed/Typed) Jerry Kenczi	(a	^{Date} MAY 2 1 2014
Assistant Field Manager Lands & Mineral Resources	Office ERNAL FIELD OFFICE		
pplication approval does not warrant or certify the applicant holoerations thereon. onditions of approval, if any, are attached.	ds legal or equitable title to those rights in the subject lea	TYDINS OF APPROV	AL ATTACHED

Title 18 U.S.C. Section 1001 and Title 43 U.S.C. Section 1212, make it a crime for any person knowingly and willfully to make to any department or agency of the United States any false, fictitious or fraudulent statements or representations as to any matter within its jurisdiction.

Additional Operator Remarks (see next page)

Electronic Submission #213993 verified by the BLM Well Information System For NEWFIELD EXPLORATION COMPANY, sent to the Vernal Committed to AFMSS for processing by JOHNETTA MAGEE on 07/23/2013 (13JM0465AE)

NOTICE OF APPROVAL



UNITED STATES DEPARTMENT OF THE INTERIOR BUREAU OF LAND MANAGEMENT VERNAL FIELD OFFICE

VERNAL, UT 84078

(435) 781-4400



CONDITIONS OF APPROVAL FOR APPLICATION FOR PERMIT TO DRILL

Company: Well No:

API No:

Newfield Production Company

170 South 500 East

GBMU D-31-8-18

43-013-53895

Location: Lease No:

LOT 4, Sec. 30, T8S, R18E

UTU-75532

Agreement:

OFFICE NUMBER:

(435) 781-4400

OFFICE FAX NUMBER:

(435) 781-3420

A COPY OF THESE CONDITIONS SHALL BE FURNISHED TO YOUR FIELD REPRESENTATIVE TO INSURE COMPLIANCE

All lease and/or unit operations are to be conducted in such a manner that full compliance is made with the applicable laws, regulations (43 CFR Part 3160), and this approved Application for Permit to Drill including Surface and Downhole Conditions of Approval. The operator is considered fully responsible for the actions of his subcontractors. A copy of the approved APD must be on location during construction, drilling, and completion operations. This permit is approved for a two (2) year period, or until lease expiration, whichever occurs first. An additional extension, up to two (2) years, may be applied for by sundry notice prior to expiration.

NOTIFICATION REQUIREMENTS

Location Construction (Notify Environmental Scientist)	 Forty-Eight (48) hours prior to construction of location and access roads.
Location Completion (Notify Environmental Scientist)	- Prior to moving on the drilling rig.
Spud Notice (Notify Petroleum Engineer)	- Twenty-Four (24) hours prior to spudding the well.
Casing String & Cementing (Notify Supv. Petroleum Tech.)	 Twenty-Four (24) hours prior to running casing and cementing all casing strings to: blm_ut_vn_opreport@blm.gov
BOP & Related Equipment Tests (Notify Supv. Petroleum Tech.)	- Twenty-Four (24) hours prior to initiating pressure tests.
First Production Notice (Notify Petroleum Engineer)	 Within Five (5) business days after new well begins or production resumes after well has been off production for more than ninety (90) days.

Page 2 of 9 Well: GMBU D-31-8-18 5/15/2014

SURFACE USE PROGRAM CONDITIONS OF APPROVAL (COAs)

- All new and replacement internal combustion gas field engines of less than or equal to 300 designrated horsepower must not emit more than 2 gms of NO_x per horsepower-hour. This requirement does not apply to gas field engines of less than or equal to 40 design-rated horsepower.
- All and replacement internal combustion gas field engines of greater than 300 design rated horsepower must not emit more than 1.0 gms of NO_x per horsepower-hour.
- If there is an active Gilsonite mining operation within 2 miles of the well location, operator shall notify the Gilsonite operator at least 48 hours prior to any blasting during construction.
- If paleontological materials are uncovered during construction, the operator is to immediately stop
 work and contact the Authorized Officer (AO). A determination will be made by the AO as to what
 mitigation may be necessary for the discovered paleontologic material before construction can
 continue.

Green River District Reclamation Guidelines

The Operator will comply with the requirements of the *Green River District (GRD) Reclamation Guidelines* formalized by Green River District Instructional Memo UTG000-2011-003 on March 28, 2011.

Documentation of the compliance will be as follows:

- The operator shall submit a Sundry Notice (Form 3160-5) to the BLM Authorized Officer (AO) that
 designates the proposed site-specific monitoring and reference sites chosen for the location. A
 description of the proposed sites shall be included, as well as a map showing the locations of the
 proposed sites.
- The operator shall submit a Sundry Notice (Form 3160-5) to the BLM Authorized Officer (AO) 3
 growing seasons after reclamation efforts have occurred evaluating the status of the reclaimed
 areas in order to determine whether the BLM standards set forth in the GRD Reclamation
 Guidelines have been met (30% or greater basal cover).
- Prior to beginning new surface disturbance, the operator shall submit a Sundry Notice (Form 3160-5) to the BLM Authorized Officer (AO) providing the results of the noxious weed inventory described in the GRD Reclamation Guidelines (2011). If weeds are found the report shall include 1) A GPS location recorded in North American Datum 1983; 2) species; 3) canopy cover or number of plants; 4) and size of infestation (estimate square feet or acres. Information shall be also documented in the reclamation report.

CONDITIONS OF APPROVAL

Wildlife

In accordance with the Record of Decision for the Castle Peak and Eightmile Flat Oil and Gas Expansion Project, Newfield Rocky Mountains Inc., the following COA's are required:

 WFM-1 On level or gently sloping ground (5 percent slope or less) Newfield will elevate surface pipelines (4 inches or greater in diameter) a minimum of 6 inches above the ground to allow

Page 3 of 9 Well: GMBU D-31-8-18

5/15/2014

passage of small animals beneath the pipe. This ground clearance will be achieved by placing the pipeline on blocks at intervals of 150 to 200 feet.

 WFM-4 Newfield will install noise reduction devices on all pump jacks to reduce intermittent noise to 45 dBA at 660 feet from the source.

COAs derived from mitigation measure in the EA:

1. Burrowing Owl (Athene cunicularia)

If it is anticipated that construction or drilling will occur during burrowing owl nesting season (March 1st through August 31st) a BLM biologist will be notified to determine if surveys are necessary prior to beginning operations. If surveys are deemed necessary, depending on the results permission to proceed may or may not, be granted by the BLM Authorized Officer. Based on the results of the survey, permission to proceed may or may not be granted.

For protection of T&E Fish if drawing water from the Green River

- For areas of fresh water collection, an infiltration gallery will be constructed in a Service approved location. An infiltration gallery is basically a pit or trench dug within the floodplain to a depth below the water table. Water is drawn from the pit rather than from the river directly. If this is not possible, limit pumping within the river to off-channel locations that do not connect to the river during high spring flows.
- If water cannot be drawn using the measures above and the pump head will be located in the river channel where larval fish are known to occur, the following measures apply:
 - Avoid pumping from low-flow or no-flow areas as these habitats tend to concentrate larval fished
 - Avoid pumping to the greatest extent possible, during that period of the year when larval fish may be present (see previous bullet); and
 - Avoid pumping, to the greatest extent possible, during the midnight hours (10:00 p.m. to 2:00 a.m.) as larval drift studies indicate that this is a period of greatest daily activity. Dusk is the preferred pumping time, as larval drift abundance is lowest during this time.
 - o Screen all pump intakes with 3/32-inch mesh material.
- Report any fish impinged on the intake screen to the FWS office (801.975.3330) and the:

Utah Division of Wildlife Resources Northeastern Region 318 North Vernal Ave. Vernal, UT 84078 (435) 781-9453

Air Quality

- All internal combustion equipment will be kept in good working order.
- Water or other approved dust suppressants will be used at construction sites and along roads, as determined appropriate by the Authorized Officer. Dust suppressant such as magnesium chloride or fresh water may be used, as needed, during the drilling phase.
- Open burning of garbage or refuse will not occur at well sites or other facilities.
- Drill rigs will be equipped with Tier II or better diesel engines.
- Low bleed pneumatics will be installed on separator dump valves and other controllers.

Page 4 of 9 Well: GMBU D-31-8-18 5/15/2014

- During completion, no venting will occur, and flaring will be limited as much as possible. Production
 equipment and gathering lines will be installed as soon as possible.
- Telemetry will be installed to remotely monitor and control production.
- When feasible, two or more rigs (including drilling and completion rigs) will not be run simultaneously within 200 meters of each other. If two or more rigs must be run simultaneously within 200 meters of each other, then effective public health buffer zones out to 200 meters (m) from the nearest emission source will be implemented. Examples of an effective public health protection buffer zone include the demarcation of a public access exclusion zone by signage at intervals of every 250 feet that is visible from a distance of 125 feet during daylight hours, and a physical buffer such as active surveillance to ensure the property is not accessible by the public during drilling operations. Alternatively, the proponent may demonstrate compliance with the 1-hour NO₂ National Ambient Air Quality Standards (NAAQS) with appropriate and accepted near-field modeling. As part of this demonstration, the proponent may propose alternative mitigation that could include but is not limited to natural gas—fired drill rigs, installation of NO_x controls, time/use restrictions, and/or drill rig spacing.
- Green completions will be used for all well completion activities where technically feasible.
- Employ enhanced VOC emission controls with 95% control efficiency on production equipment having a potential to emit greater than 5 tons per year.

Threatened and Endangered Plants

- From one year of the date forward of 100% Sclerocactus clearance survey for this project, spot checks will be conducted and approved for all planned disturbance areas on an annual basis. (The S. brevispinus survey period is defined as mid-March to June 30, and the S. wetlandicus survey period is defined as anytime without snow cover prior.) Results of spot checks may require additional pre-construction plant surveys as directed by the BLM. If the proposed action or parts thereof have not occurred within four years of the original survey, 100% clearance re-survey will be required prior to ground disturbing activities.
- Newfield will perform ground disturbing activities in Sclerocactus Core Conservation Areas (CCAs) outside of the flowering period, April 1 through May 30.
- Only water (no chemicals, reclaimed production water or oil field brine) will be used for dust abatement measures within cactus habitat.
- Dust abatement will be employed in suitable Sclerocactus habitat over the life of the project during the time of the year when Sclerocactus species are most vulnerable to dust-related impacts (March through August).
- The seed mix will be amended to exclude Snake river wheatgrass, (not endemic to Utah) and Siberian wheatgrass (introduced).
- Erosion control measures (i.e. silt fencing) will be implemented to minimize sedimentation to Sclerocactus plants and populations located down slope of proposed surface disturbance activities.

Page 5 of 9 Well: GMBU D-31-8-18 5/15/2014

 Discovery Stipulation: Re-initiation of Section 7 consultation with the USFWS will be sought immediately if any loss of plants or occupied habitat for Pariette cactus or Uinta Basin hookless cactus is anticipated as a result of project activities.

Page 6 of 9 Well: GMBU D-31-8-18 5/15/2014

DOWNHOLE PROGRAM CONDITIONS OF APPROVAL (COAs)

SITE SPECIFIC DOWNHOLE COAs:

 Newfield Production Co. shall adhere to all referenced requirements in the SOP (version: "Greater Monument Butte Green River Development Program", Feb 16, 2012). The operator shall also comply with applicable laws and regulations; with lease terms Onshore Oil and Gas Orders, NTL's; and with other orders and instructions of the, authorized officer.

All provisions outlined in Onshore Oil & Gas Order #2 Drilling Operations shall be strictly adhered to. The following items are emphasized:

DRILLING/COMPLETION/PRODUCING OPERATING STANDARDS

- The spud date and time shall be reported orally to Vernal Field Office within 24 hours of spudding.
- Notify Vernal Field Office Supervisory Petroleum Engineering Technician at least 24 hours in advance of casing cementing operations and BOPE & casing pressure tests.
- All requirements listed in Onshore Order #2 III. E. Special Drilling Operations are applicable for air drilling of surface hole.
- Blowout prevention equipment (BOPE) shall remain in use until the well is completed or abandoned. Closing unit controls shall remain unobstructed and readily accessible at all times. Choke manifolds shall be located outside of the rig substructure.
- All BOPE components shall be inspected daily and those inspections shall be recorded in the daily drilling report. Components shall be operated and tested as required by Onshore Oil & Gas Order No. 2 to insure good mechanical working order. All BOPE pressure tests shall be performed by a test pump with a chart recorder and <u>NOT</u> by the rig pumps. Test shall be reported in the driller's log.
- BOP drills shall be initially conducted by each drilling crew within 24 hours of drilling out from under the surface casing and weekly thereafter as specified in Onshore Oil & Gas Order No. 2.
- Casing pressure tests are required before drilling out from under all casing strings set and cemented in place.
- No aggressive/fresh hard-banded drill pipe shall be used within casing.
- Cement baskets shall not be run on surface casing.
- The operator must report all shows of water or water-bearing sands to the BLM. If flowing water is
 encountered it must be sampled, analyzed, and a copy of the analyses submitted to the BLM Vernal
 Field Office.
- The operator must report encounters of all non oil & gas mineral resources (such as Gilsonite, tar sands, oil shale, trona, etc.) to the Vernal Field Office, in writing, within 5 working days of each encounter. Each report shall include the well name/number, well location, date and depth (from KB

Page 7 of 9 Well: GMBU D-31-8-18 5/15/2014

or GL) of encounter, vertical footage of the encounter and, the name of the person making the report (along with a telephone number) should the BLM need to obtain additional information.

- A complete set of angular deviation and directional surveys of a directional well will be submitted to the Vernal BLM office engineer within 30 days of the completion of the well.
- While actively drilling, chronologic drilling progress reports shall be filed directly with the BLM, Vernal Field Office on a weekly basis in sundry, letter format or e-mail to the Petroleum Engineers until the well is completed.
- A cement bond log (CBL) will be run from the production casing shoe to the top of cement and shall be utilized to determine the bond quality for the production casing. Submit a field copy of the CBL to this office.
- Please submit an electronic copy of all other logs run on this well by CD (compact disc).
 This submission will supersede the requirement for submittal of paper logs to the BLM.
- There shall be no deviation from the proposed drilling, completion, and/or workover program as approved. Safe drilling and operating practices must be observed. Any changes in operation must have prior approval from the BLM Vernal Field Office.

Page 8 of 9 Well: GMBU D-31-8-18 5/15/2014

OPERATING REQUIREMENT REMINDERS:

 All wells, whether drilling, producing, suspended, or abandoned, shall be identified in accordance with 43 CFR 3162.6. There shall be a sign or marker with the name of the operator, lease serial number, well number, and surveyed description of the well.

- For information regarding production reporting, contact the Office of Natural Resources Revenue (ONRR) at www.ONRR.gov.
- Should the well be successfully completed for production, the BLM Vernal Field office must be
 notified when it is placed in a producing status. Such notification will be by written communication
 and must be received in this office by not later than the fifth business day following the date on
 which the well is placed on production. The notification shall provide, as a minimum, the following
 informational items:
 - o Operator name, address, and telephone number.
 - Well name and number.
 - o Well location (1/4/4, Sec., Twn, Rng, and P.M.).
 - Date well was placed in a producing status (date of first production for which royalty will be paid).
 - o The nature of the well's production, (i.e., crude oil, or crude oil and casing head gas, or natural gas and entrained liquid hydrocarbons).
 - The Federal or Indian lease prefix and number on which the well is located; otherwise the non-Federal or non-Indian land category, i.e., State or private.
 - o Unit agreement and/or participating area name and number, if applicable.
 - o Communitization agreement number, if applicable.
- Any venting or flaring of gas shall be done in accordance with Notice to Lessees (NTL) 4A and needs prior approval from the BLM Vernal Field Office.
- All undesirable events (fires, accidents, blowouts, spills, discharges) as specified in NTL 3A will be reported to the BLM, Vernal Field Office. Major events, as defined in NTL3A, shall be reported verbally within 24 hours, followed by a written report within 15 days. "Other than Major Events" will be reported in writing within 15 days. "Minor Events" will be reported on the Monthly Report of Operations and Production.
- Whether the well is completed as a dry hole or as a producer, "Well Completion and Recompletion Report and Log" (BLM Form 3160-4) shall be submitted not later than 30 days after completion of the well or after completion of operations being performed, in accordance with 43 CFR 3162.4-1. Two copies of all logs run, core descriptions, and all other surveys or data obtained and compiled during the drilling, workover, and/or completion operations, shall be filed on BLM Form 3160-4. Submit with the well completion report a geologic report including, at a minimum, formation tops, and a summary and conclusions. Also include deviation surveys, sample descriptions, strip logs, core data, drill stem test data, and results of production tests if performed. Samples (cuttings, fluid,

Page 9 of 9 Well: GMBU D-31-8-18 5/15/2014

and/or gas) shall be submitted only when requested by the BLM, Vernal Field Office.

- All off-lease storage, off-lease measurement, or commingling on-lease or off-lease, shall have prior written approval from the BLM Vernal Field Office.
- Oil and gas meters shall be calibrated in place prior to any deliveries. The BLM Vernal Field Office Petroleum Engineers will be provided with a date and time for the initial meter calibration and all future meter proving schedules. A copy of the meter calibration reports shall be submitted to the BLM Vernal Field Office. All measurement facilities will conform to the API standards for liquid hydrocarbons and the AGA standards for natural gas measurement. All measurement points shall be identified as the point of sale or allocation for royalty purposes.
- A schematic facilities diagram as required by Onshore Oil & Gas Order No. 3 shall be submitted to the BLM Vernal Field Office within 30 days of installation or first production, whichever occurs first. All site security regulations as specified in Onshore Oil & Gas Order No. 3 shall be adhered to. All product lines entering and leaving hydrocarbon storage tanks will be effectively sealed in accordance with Onshore Oil & Gas Order No. 3.
- Any additional construction, reconstruction, or alterations of facilities, including roads, gathering lines, batteries, etc., which will result in the disturbance of new ground, shall require the filing of a suitable plan and need prior approval of the BLM Vernal Field Office. Emergency approval may be obtained orally, but such approval does not waive the written report requirement.
- No location shall be constructed or moved, no well shall be plugged, and no drilling or workover
 equipment shall be removed from a well to be placed in a suspended status without prior approval
 of the BLM Vernal Field Office. If operations are to be suspended for more than 30 days, prior
 approval of the BLM Vernal Field Office shall be obtained and notification given before resumption
 of operations.
- Pursuant to Onshore Oil & Gas Order No. 7, this is authorization for pit disposal of water produced from this well for a period of 90 days from the date of initial production. A permanent disposal method must be approved by this office and in operation prior to the end of this 90-day period. In order to meet this deadline, an application for the proposed permanent disposal method shall be submitted along with any necessary water analyses, as soon as possible, but no later than 45 days after the date of first production. Any method of disposal which has not been approved prior to the end of the authorized 90-day period will be considered as an Incident of Noncompliance and will be grounds for issuing a shut-in order until an acceptable manner for disposing of said water is provided and approved by this office.
- Unless the plugging is to take place immediately upon receipt of oral approval, the Field Office Petroleum Engineers must be notified at least 24 hours in advance of the plugging of the well, in order that a representative may witness plugging operations. If a well is suspended or abandoned, all pits must be fenced immediately until they are backfilled. The "Subsequent Report of Abandonment" (Form BLM 3160-5) must be submitted within 30 days after the actual plugging of the well bore, showing location of plugs, amount of cement in each, and amount of casing left in hole, and the current status of the surface restoration.

Sundry Number: 53230 API Well Number: 43047538950000

			FORM 9	
	STATE OF UTAH			
DEPARTMENT OF NATURAL RESOURCES DIVISION OF OIL, GAS, AND MINING			5.LEASE DESIGNATION AND SERIAL NUMBER: UTU-75532	
SUNDRY NOTICES AND REPORTS ON WELLS			6. IF INDIAN, ALLOTTEE OR TRIBE NAME:	
	oposals to drill new wells, significantly dee reenter plugged wells, or to drill horizontal n for such proposals.		7.UNIT or CA AGREEMENT NAME: GMBU (GRRV)	
1. TYPE OF WELL Oil Well			8. WELL NAME and NUMBER: GMBU D-31-8-18	
2. NAME OF OPERATOR: NEWFIELD PRODUCTION CO	DMPANY		9. API NUMBER: 43047538950000	
3. ADDRESS OF OPERATOR: Rt 3 Box 3630 , Myton, UT		ONE NUMBER: xt	9. FIELD and POOL or WILDCAT: 8 MILE FLAT NORTH	
4. LOCATION OF WELL FOOTAGES AT SURFACE: 0662 FSL 0535 FWL			COUNTY: UINTAH	
QTR/QTR, SECTION, TOWNSH	HIP, RANGE, MERIDIAN: 30 Township: 08.0S Range: 18.0E Meridian	: S	STATE: UTAH	
11. CHEC	K APPROPRIATE BOXES TO INDICATE N	NATURE OF NOTICE, REPOF	RT, OR OTHER DATA	
TYPE OF SUBMISSION		TYPE OF ACTION		
	ACIDIZE	ALTER CASING	CASING REPAIR	
NOTICE OF INTENT Approximate date work will start:	CHANGE TO PREVIOUS PLANS	CHANGE TUBING	CHANGE WELL NAME	
7/25/2014	CHANGE WELL STATUS	COMMINGLE PRODUCING FORMATIONS	CONVERT WELL TYPE	
SUBSEQUENT REPORT	DEEPEN	FRACTURE TREAT	NEW CONSTRUCTION	
Date of Work Completion:				
	☐ ☐ OPERATOR CHANGE ☐	PLUG AND ABANDON	L PLUG BACK	
SPUD REPORT	PRODUCTION START OR RESUME	RECLAMATION OF WELL SITE	☐ RECOMPLETE DIFFERENT FORMATION	
Date of Spud:	REPERFORATE CURRENT FORMATION	SIDETRACK TO REPAIR WELL	L TEMPORARY ABANDON	
	TUBING REPAIR	VENT OR FLARE	WATER DISPOSAL	
DRILLING REPORT Report Date:	WATER SHUTOFF	SI TA STATUS EXTENSION	✓ APD EXTENSION	
	WILDCAT WELL DETERMINATION	OTHER	OTHER:	
Newfield proposes t	COMPLETED OPERATIONS. Clearly show all performed to extend the Application for Performed Perform			
NAME (PLEASE PRINT) Mandie Crozier	PHONE NUMBER 435 646-4825	Regulatory Tech		
SIGNATURE N/A		DATE 7/10/2014		

Sundry Number: 53230 API Well Number: 43047538950000



The Utah Division of Oil, Gas, and Mining

- State of Utah
- Department of Natural Resources

Electronic Permitting System - Sundry Notices

Title: Regulatory Tech Representing: NEWFIELD PRODUCTION COMPANY

Request for Permit Extension Validation Well Number 43047538950000

API: 43047538950000 **Well Name:** GMBU D-31-8-18

Location: 0662 FSL 0535 FWL QTR SWSW SEC 30 TWNP 080S RNG 180E MER S

Company Permit Issued to: NEWFIELD PRODUCTION COMPANY

Date Original Permit Issued: 7/25/2013

The undersigned as owner with legal rights to drill on the property as permitted above, hereby verifies that the information as submitted in the previously approved application to drill, remains valid and does not require revision. Following is a checklist of some items related to the application, which should be verified.

ronowing is a checklist of some items related to the application, which should be verified.
 If located on private land, has the ownership changed, if so, has the surface agreement been updated? Yes No
 Have any wells been drilled in the vicinity of the proposed well which would affect the spacing or siting requirements for this location? Yes No
 Has there been any unit or other agreements put in place that could affect the permitting or operation of this proposed well? Yes No
 Have there been any changes to the access route including ownership, or rightof- way, which could affect the proposed location? Yes No
• Has the approved source of water for drilling changed? 🔘 Yes 📵 No
 Have there been any physical changes to the surface location or access route which will require a change in plans from what was discussed at the onsite evaluation? Yes No
• Is bonding still in place, which covers this proposed well? 🌘 Yes 🔘 No
Signature: Mandie Crozier Date: 7/10/2014

RECEIVED: Jul. 10, 2014

Sundry Number: 64140 API Well Number: 43047538950000

	STATE OF UTAH		FORM 9	
	DEPARTMENT OF NATURAL RESOURCES DIVISION OF OIL, GAS, AND MININ		5.LEASE DESIGNATION AND SERIAL NUMBER: UTU-75532	
SUNDRY NOTICES AND REPORTS ON WELLS			6. IF INDIAN, ALLOTTEE OR TRIBE NAME:	
	oposals to drill new wells, significantly dee reenter plugged wells, or to drill horizontal n for such proposals.		7.UNIT or CA AGREEMENT NAME: GMBU (GRRV)	
1. TYPE OF WELL Oil Well			8. WELL NAME and NUMBER: GMBU D-31-8-18	
2. NAME OF OPERATOR: NEWFIELD PRODUCTION CO	OMPANY		9. API NUMBER: 43047538950000	
3. ADDRESS OF OPERATOR: Rt 3 Box 3630 , Myton, UT		IONE NUMBER:	9. FIELD and POOL or WILDCAT: 8 MILE FLAT NORTH	
4. LOCATION OF WELL FOOTAGES AT SURFACE:			COUNTY: UINTAH	
0662 FSL 0535 FWL QTR/QTR, SECTION, TOWNSH Qtr/Qtr: SWSW Section:	HIP, RANGE, MERIDIAN: 30 Township: 08.0S Range: 18.0E Meridian	n: S	STATE: UTAH	
11. CHEC	K APPROPRIATE BOXES TO INDICATE N	NATURE OF NOTICE, REPOF	RT, OR OTHER DATA	
TYPE OF SUBMISSION		TYPE OF ACTION		
	CHANGE TO PREVIOUS PLANS CHANGE WELL STATUS DEEPEN OPERATOR CHANGE PRODUCTION START OR RESUME REPERFORATE CURRENT FORMATION TUBING REPAIR WATER SHUTOFF WILDCAT WELL DETERMINATION COMPLETED OPERATIONS. Clearly show all parts of extend the Application for Parts of the Application of the App			
NAME (PLEASE PRINT) Mandie Crozier	PHONE NUMBER 435 646-4825	TITLE Regulatory Tech		
SIGNATURE N/A	100 040 4020	DATE 6/23/2015		

Sundry Number: 64140 API Well Number: 43047538950000



The Utah Division of Oil, Gas, and Mining

- State of Utah
- Department of Natural Resources

Electronic Permitting System - Sundry Notices

Request for Permit Extension Validation Well Number 43047538950000

API: 43047538950000 **Well Name:** GMBU D-31-8-18

Location: 0662 FSL 0535 FWL QTR SWSW SEC 30 TWNP 080S RNG 180E MER S

Company Permit Issued to: NEWFIELD PRODUCTION COMPANY

Date Original Permit Issued: 7/25/2013

The undersigned as owner with legal rights to drill on the property as permitted above, hereby verifies that the information as submitted in the previously approved application to drill, remains valid and does not require revision. Following is a checklist of some items related to the application, which should be verified.

• If located on private land, has the ownership changed, if so, has the surface agreement been updated? Yes No
 Have any wells been drilled in the vicinity of the proposed well which would affect the spacing or siting requirements for this location? Yes No
 Has there been any unit or other agreements put in place that could affect the permitting or operation of this proposed well? Yes No
 Have there been any changes to the access route including ownership, or rightof- way, which could affect the proposed location? Yes No
• Has the approved source of water for drilling changed? Yes No
 Have there been any physical changes to the surface location or access route which will require a change in plans from what was discussed at the onsite evaluation? Yes No
• Is bonding still in place, which covers this proposed well? Yes No
nature: Mandie Crozier Date: 6/23/2015

Title: Regulatory Tech Representing: NEWFIELD PRODUCTION COMPANY

UNITED STATES DEPARTMENT OF THE INTERIOR BUREAU OF LAND MANAGEMENT

RECEIVED

FORM APPROVED
OMB NO. 1004-0135
Expires: July 31, 2010
Lease Serial No

SUNDRY NOTICES AND REPORTS ON WELLS

Do not use this form for proposals to drill or to re-enter in 2 2016

UTU75532

Do not use the abandoned we	is form for proposals to drill or ill. Use form 3160-3 (APD) for s	to re-enters	<i>n</i> .0 2 2	016 6.	If Indian, Allottee of	Tribe Name
SUBMIT IN TRI	PLICATE - Other instructions of	on religieriste si	Be RNAL	UTAH 7.	If Unit or CA/Agree UTU87538X	ment, Name and/or No.
Type of Well Oil Well	her			8.	Well Name and No. GMBU D-31-8-18	· · · · · · · · · · · · · · · · · · ·
2. Name of Operator		E CROZIER FIELD.COM		9.	API Well No. 43-047-53895	
3a. Address ROUTE 3 BOX 3630 MYTON, UT 84052	3b. Ph Ph: 4	one No. (include 35-646-4825	o. (include area code) 10. 46-4825). Field and Pool, or I MONUMENT BU	Exploratory JTTE
4. Location of Well (Footage, Sec., T	., R., M., or Survey Description)		,	11	. County or Parish, a	nd State
Sec 30 T8S R18E Mer SLB S	WSW 662FSL 535FWL				UINTAH COUNT	ry, ut
12. CHECK APPE	ROPRIATE BOX(ES) TO INDIC	CATE NATU	JRE OF N	OTICE, REP	ORT, OR OTHER	R DATA
TYPE OF SUBMISSION			TYPE OF	ACTION		
Notice of Intent	☐ Acidize [] Deepen		☐ Production	(Start/Resume)	☐ Water Shut-Off
	☐ Alter Casing [Fracture Tre	at	□ Reclamatio	n	■ Well Integrity
☐ Subsequent Report	☐ Casing Repair	☐ New Constr	uction	☐ Recomplete	•	Other
☐ Final Abandonment Notice	☐ Change Plans	☐ Plug and Ab	andon	□ Temporaril	y Abandon	Change to Original A PD
	☐ Convert to Injection [Plug Back		■ Water Disp	osal	
Newfield proposes to extend the approved on 5/21/14. NEPA — 2014 - 62	he Application for Permit to Drill t	his well. The	RECE JUN 2	APD was	VERNAL F ENG. RAH GEOL	TELD OFFICE
14. I hereby certify that the foregoing is	true and correct				/E1	
14. Thereby certify that the foregoing is	Electronic Submission #338201 v For NEWFIELD PRODUC	verified by the TION COMPA	BL M Well NY, sent t	Information Sy o the Vernal	stem ECL	
Name (Printed/Typed) MANDIE C	CROZIER	Title	REGULA	ATORY SPECI	ALIST	·
Signature (Electronic S	submission)	Date	05/02/20	16		
	THIS SPACE FOR FED	ERAL OR	STATE (FFICE USE		
Approved By Jy Liquid	4	Title		istant Field Mi s & Mineral Re		MAY 1 2 2016
Conditions of approved if any are attached certify that the applicant holds legal or equivalent would entitle the applicant to conductive the applicant to conduct the applicant to conductive the app	itable title to those rights in the subject le	ease Office	VEF	RNALFIEL	OFFICE	
Fitle 18 U.S.C. Section 1001 and Title 43 U.S. States any false, fictitious or fraudulent states.				willfully to make t	o any department or a	gency of the United

** OPERATOR-SUBMI

CONDITIONS OF APPROVAL

Newfield Exploration Company

Notice of Intent APD Extension

Lease:

UTU-75532

Well:

GMBU D-31-8-18

Location:

SWSW Sec 30-T8S-R18E

An extension for the referenced APD is granted with the following conditions:

- 1. The extension and APD shall expire on 05/21/2018.
- 2. No other extension shall be granted.

If you have any other questions concerning this matter, please contact Robin L Hansen of this office at (435) 781-2777

Sundry Number: 73030 API Well Number: 43047538950000

			1
	STATE OF UTAH		FORM 9
	DEPARTMENT OF NATURAL RESOURCE DIVISION OF OIL, GAS, AND MINI		5.LEASE DESIGNATION AND SERIAL NUMBER: UTU-75532
SUNDRY NOTICES AND REPORTS ON WELLS			6. IF INDIAN, ALLOTTEE OR TRIBE NAME:
Do not use this form for proposals to drill new wells, significantly deepen existing wells below current bottom-hole depth, reenter plugged wells, or to drill horizontal laterals. Use APPLICATION FOR PERMIT TO DRILL form for such proposals.		7.UNIT or CA AGREEMENT NAME: GMBU (GRRV)	
1. TYPE OF WELL Oil Well		8. WELL NAME and NUMBER: GMBU D-31-8-18	
2. NAME OF OPERATOR: NEWFIELD PRODUCTION CO	OMPANY		9. API NUMBER: 43047538950000
3. ADDRESS OF OPERATOR: Rt 3 Box 3630 , Myton, UT		PHONE NUMBER: Ext	9. FIELD and POOL or WILDCAT: 8 MILE FLAT NORTH
4. LOCATION OF WELL FOOTAGES AT SURFACE: 0662 FSL 0535 FWL			COUNTY: UINTAH
QTR/QTR, SECTION, TOWNSI Qtr/Qtr: SWSW Section:	HIP, RANGE, MERIDIAN: 30 Township: 08.0S Range: 18.0E Meridia	an: S	STATE: UTAH
11. CHEC	K APPROPRIATE BOXES TO INDICATE	E NATURE OF NOTICE, REPOR	RT, OR OTHER DATA
TYPE OF SUBMISSION		TYPE OF ACTION	
	ACIDIZE	ALTER CASING	CASING REPAIR
NOTICE OF INTENT Approximate date work will start:	CHANGE TO PREVIOUS PLANS	CHANGE TUBING	CHANGE WELL NAME
7/25/2016	CHANGE WELL STATUS	COMMINGLE PRODUCING FORMATIONS	CONVERT WELL TYPE
SUBSEQUENT REPORT	DEEPEN [FRACTURE TREAT	New construction
Date of Work Completion:	OPERATOR CHANGE	PLUG AND ABANDON	PLUG BACK
SPUD REPORT Date of Spud:	PRODUCTION START OR RESUME	RECLAMATION OF WELL SITE	☐ RECOMPLETE DIFFERENT FORMATION
Date or Spud:	REPERFORATE CURRENT FORMATION	SIDETRACK TO REPAIR WELL	LI TEMPORARY ABANDON
	L TUBING REPAIR	VENT OR FLARE	WATER DISPOSAL
DRILLING REPORT Report Date:	WATER SHUTOFF	SI TA STATUS EXTENSION	✓ APD EXTENSION
	WILDCAT WELL DETERMINATION	OTHER	OTHER:
12. DESCRIBE PROPOSED OR	COMPLETED OPERATIONS. Clearly show all	l pertinent details including dates, o	depths, volumes, etc.
Newfield proposes	to extend the Application for	Permit to Drill this well.	
			Utally D2vi2016of Oil, Gas and Mining
			= -
			Date:
			By: Dally
NAME (DI EASE DRINT)	PHONE NUMBE	R TITLE	
NAME (PLEASE PRINT) Mandie Crozier	435 646-4825	Regulatory Tech	
SIGNATURE N/A		DATE 7/11/2016	

Sundry Number: 73030 API Well Number: 43047538950000



The Utah Division of Oil, Gas, and Mining

- State of Utah
- Department of Natural Resources

Electronic Permitting System - Sundry Notices

Title: Regulatory Tech Representing: NEWFIELD PRODUCTION COMPANY

Request for Permit Extension Validation Well Number 43047538950000

API: 43047538950000 **Well Name:** GMBU D-31-8-18

Location: 0662 FSL 0535 FWL QTR SWSW SEC 30 TWNP 080S RNG 180E MER S

Company Permit Issued to: NEWFIELD PRODUCTION COMPANY

Date Original Permit Issued: 7/25/2013

The undersigned as owner with legal rights to drill on the property as permitted above, hereby verifies that the information as submitted in the previously approved application to drill, remains valid and does not require revision. Following is a checklist of some items related to the application, which should be verified.

to downing is a checknist of some items related to the application, which should be verified.
 If located on private land, has the ownership changed, if so, has the surface agreement been updated? Yes No
 Have any wells been drilled in the vicinity of the proposed well which would affect the spacing or siting requirements for this location? Yes No
 Has there been any unit or other agreements put in place that could affect the permitting or operation of this proposed well? Yes No
 Have there been any changes to the access route including ownership, or rightof- way, which could affect the proposed location? Yes No
• Has the approved source of water for drilling changed? 🔘 Yes 📵 No
 Have there been any physical changes to the surface location or access route which will require a change in plans from what was discussed at the onsite evaluation? Yes No
• Is bonding still in place, which covers this proposed well? 🃵 Yes 🔘 No
Signature: Mandie Crozier Date: 7/11/2016

RECEIVED: Jul. 11, 2016